

65 Civic Avenue Pittsburg, CA 94565 P: (925) 252-6900 F: (925) 252-4814

pittsburgca.gov

Community and Economic Development Department – Planning Division

#### Memorandum

MEMO:	October 9, 2024
TO:	Zoning Administrator
FROM:	Maurie Brenyah-Addow, Senior Planner

#### RE: Fisherman's Catch, 2685 East Leland Road, AP-24-0085 (AUP, DR).

ORIGINATED BY: Wolfgang Croskey, (925) 415-6076, wolf@croskeyrealestate.com

SUBJECT: This is an application filed by Wolfgang Croskey, on behalf of Fisherman's Catch, for an Administrative Use Permit (AUP) and Design Review (DR) to establish a commercial seafood store and processing operation in the IL-O zone and make minor exterior and site enhancements to existing commercial building located at 2685 East Leland Road. AP-24-0085; APN: 088-152-017

#### **RECOMMENDATION:**

Staff recommends that the Zoning Administrator adopt a Resolution (Attachment 1), approving Use Permit and Design Review Application No. 24-0085, subject to conditions.

#### BACKGROUND:

The project site is 0.90-acre site located at 2685 East Leland Road and previously served as a Lumber Liquidators store. The 2040 General Plan Land Use Map changed the General Plan designation from Business Commercial to Employment Center Industrial (ECI). The site is among five sites that recently underwent a series of Zoning Map Amendments to implement new land use designations consistent with the 2040 General Plan Land Use Map, as required by Government Code Section 65860.

Subsequently, the city initiated a rezoning of the parcel from CS (Service Commercial District) to IL-O (Limited Industrial with Limited Overlay District) to allow for limited food processing, custom manufacturing and light industrial uses.

On August 13, 2024, a Notice of Intent to conduct a Zoning Administrator hearing for this project was included on the Planning Commission agenda consistent with PMC section 18.10.050.

**PROJECT DESCRIPTION:** 

Existing Conditions:

The project site is a 0.90-acre site containing an 8,074 square-foot commercial building that formerly was a Lumber Liquidators store for hardwood floors. The site has two driveways, maneuvering aisles that encircle the building, and parking areas at the front, sides and rear. It also has landscaping strips and islands with some trees, shrubbery and scant groundcover for landscaping.

There is an existing monument sign within the landscaping area adjacent to the sidewalk, and an existing billboard next to a small trash enclosure at the rear of the property.

See Attachment 2 for Existing Conditions Photos.

Surrounding Land Uses:

North: Highway 4 (adjacent) West: Autos Sales Lot (adjacent) South: Los Medanos Community College East: Multi-family residential units

See Attachment 3 for Map of Surrounding Land Uses.

Proposed Project:

The Fisherman's Catch project proposes to establish a seafood processing operation at the site with a specialization in crab products. The day-to-day activities are very minimal in part because they will not involve boiling or cooking of the crab. The application proposes to operate a facility that will maintain the industry standards of hygiene and quality control and that fully complies with United States Department of Agriculture (USDA) and Food and Drug Administration (FDA) regulations.

The proposed operations are designed to handle light scale processing, including sorting, cleaning, and packaging of crab meat. The processed crabs will be promptly chilled and either stored for retail or loaded directly onto trucks for wholesale distribution. The wide range of customers, include retailers, large grocery chains, and membership clubs.

In terms of logistics, the crabs are delivered and off-loaded on-site, where they are processed and prepared for distribution. The proposal anticipates handling approximately 20,000-25,000 pounds of seafood daily, with one truckload shipped daily.

During busy seasons from December to February, Fisherman's Catch will operate with extended hours from 6:00 am to 9:00 pm to manage increased production demands. In the off-season, operations will adjust to 6:00 am-6:00 pm.

Approximately 10% of the total seafood weight becomes waste and will be collected daily by a licensed fertilizer company to be converted into fertilizer. The project will also be subject to additional precautionary measures for odor included in the Odor Impact Minimization Plan (OIMP). Additional business waste is minimal and will be managed through daily services by Mount Diablo Resources Recovery (MDRR).

The proposed Fisherman's Catch operation will have a minimum of 6 employees during the off-season (March through November) to a maximum of 50 employees on-site during the peak season (December through February).

See Attachment 4 for the Project Site and Floor Plans.

#### CODE COMPLIANCE:

<u>Pittsburg General Plan 2040</u> The site is within the 'Loveridge' Subarea of the 2040 General Plan and has a land use designation of Employment Center Industrial (ECI). The 2040 General Plan Update changed the General Plan designation from Business Commercial to Employment Center Industrial (ECI).Properties within the ECI designation are intended to foster vibrant, diverse, and dynamic employment hubs that accommodate technology, advanced manufacturing, logistics, and other sectors that generate substantial employment opportunities; uses may also include administrative, financial, business, professional, medical and public offices, business incubators, research and development, custom and light manufacturing, limited assembly, warehousing and distribution, data centers, technology and innovation, energy, hospitals and large-scale medical facilities, services, light and heavy automobile services, and supporting commercial uses.

The proposed project is consistent with General Plan Land Use Goal 2-P-4.2, in that it provides employment, and the site is fully served by public facilities and located along a major arterial – East Leland Road. The commercial building is located in a transitional area between commercial, institutional and residential along East Leland Road where there is a confluence of uses such as the adjacent auto sales lot, an existing mult-family residential apartment complex and a Los Medanos Community College across the street. The proposed project is also consistent with General Plan Land Use Goal 2-P-4.8, in that the proposal revitalizes a currently vacant and underutilized site and building.

<u>Zoning</u>: The proposal complies with the IL-O (Limited Industrial with Limited Overlay District) which allows for limited food processing, custom manufacturing and light industrial uses consistent with the 2040 General Plan Land Use Map which changed the General Plan designation from Business Commercial to Employment Center Industrial (ECI).

**Off-Street Parking**. PMC section 18.78.040 sets forth standards for off-street parking. The existing parking lot for the project site currently contains 41 parking spaces, two of which is ADA accessible. PMC section 18.78.040, Schedule A, sets forth standards for off-street parking and loading spaces required by type of use. The parking requirement is

1 space for every 750 square feet of floor area, therefore 11 spaces total and 1 loading space are required for the 8,074 square foot building. The site currently has 39 parking spaces and 2 accessible parking spaces. Therefore, no additional parking spaces are required.

**On-site Bicycle Parking.** PMC section 18.78.045 specifies a minimum number of bicycle parking stalls that must be provided on new non-residential sites based on the number of required off-street parking stalls for the use. According to this section of the PMC, for projects requiring 11 off-street parking spaces, 4 bicycle parking stall is required. Installation of the appropriate number of bicycle parking spaces will be required as a condition of approval.

**Signage.** The applicant has two existing signs (monument and wall signs) proposed to be refaced. As a condition of approval, the applicant will be required to secure a sign permit for the refacing of the existing signs.

**Waste Disposal.** Due to the nature of the proposed operations and potential for odor and other attendant nuisances, the applicant is required to store and dispose-off all organic waste in special containers kept indoors on a daily basis. The existing trash enclosure is only permitted for dry inorganic waste such as cardboards.

<u>Required Findings – Use Permit:</u> Pursuant to PMC section 18.16.040, in order to approve the Use Permit for the facility, the Zoning Administrator must find that the project:

- A. is in accord with the objective of the Zoning Ordinance, the purposes of the land use district in which it is located and is appropriate to the specific location;
- B. is not detrimental to the health, safety, and general welfare of the city;
- C. will not adversely affect the orderly development of property within the city;
- D. will not adversely affect the preservation of property values and the protection of the tax base and other substantial revenue sources within the city;
- E. is consistent with the objectives, policies, general land uses and programs specified in the general plan and applicable specific plan;
- F. will not create a nuisance or enforcement problem within the neighborhood;
- G. will not encourage marginal development within the neighborhood;
- H. will not create a demand for public services within the city beyond that of the ability of the city to meet in the light of taxation and spending restraints imposed by law;
- I. is consistent with the city's approved funding priorities; and,

J. if located within the pedestrian commercial (CP) district, will support the goals of creating a vibrant, economically prosperous, visually interesting, and engaging pedestrian oriented atmosphere along the primary downtown corridor.

<u>Required Findings – Design Review:</u> Design review approval for the project can be granted by the Zoning Administrator only after making a determination that the proposed project is consistent with PMC section 18.36.220 (B), which is summarized below:

- A. the structures conform with good taste, good design and in general contribute to the character and image of the city as a place of beauty, spaciousness, balance, taste, fitness, broad vistas, and high quality;
- B. the structures will be protected against exterior and interior noise, vibrations and other factors that may tend to make the environment less desirable;
- C. the exterior design and appearance of the structures are not of inferior quality as to cause the nature of the neighborhood to materially depreciate in appearance and value;
- D. the structures are in harmony with proposed developments on land in the general area; and
- E. the applications conform with the criteria set forth in any applicable city-adopted design guidelines.

A full analysis of how the proposed project meets the required Use Permit and Design Review findings is provided in the Resolution (Attachment 1).

<u>Environmental:</u> The proposed project is categorically exempt from the requirements of the California Environmental Quality Act (CEQA) under Class 1, "Existing Facilities," of the CEQA Guidelines, section 15301. The proposed project qualifies for a Class 1 categorical exemption because the project site is an existing, private structure and the applicant is not proposing any expansion of the existing structure. Therefore, the proposed project will not have a significant effect on the environment and is exempt from the provisions of CEQA.

If the proposed project is approved, Planning Staff will file a Notice of Exemption with the Governor's Office of Land Use and Climate Initiative (LCI) State Clearinghouse and Contra Costa County Clerk-Recorder's Office.

<u>Public Notice:</u> On or before September 27, 2024, a notice of the October 9, 2024, public hearing for the proposed project was posted at City Hall and at or near the project site; was delivered for posting at the Pittsburg Library; was posted on the "Public Notices" section of the city's website and was mailed via first class or electronic mail to the applicant, to the property owner, to all owners of property within 300 feet of the project

site, to local service agencies expected to provide services to the business, and to individuals who had previously filed written request for such notice, in accordance with PMC section 18.14.010 and Government Code section 65091. In addition, a copy of the notice was posted on www.nextdoor.com ("Nextdoor") and was sent directly to all subscribed residents in the "Harbor and School Street" and "Downtown Pittsburg" neighborhoods.

See Attachment 5 for the Public Hearing Notice.

#### ANALYSIS:

Staff believes that the Zoning Administrator can make the required findings to grant an Administrative Use Permit and Design Review approval for the proposed project. The proposed project is consistent with the 2040 General Plan, in that the existing structure is for a for limited food processing, custom manufacturing and light industrial uses.

The proposed operations are required to follow stringent set of protocols and best management practices to minimize any impacts from odors on adjacent properties. Also, the proposed operations are fully contained within an existing commercial building and no outdoor commercial operation activities are permitted for this operation. Additionally, as a condition of approval no boiling or cooking or crabs or seafood is permitted. Therefore, it would not adversely affect the orderly development of the city or encourage marginal development in the area.

See Attachment 1 for a full analysis of how the proposed project meets the required Use Permit and Design Review findings.

#### ACTION REQUIRED:

Move to adopt a Resolution, approving Use Permit application No. 24-0085, subject to conditions.

#### ATTACHMENTS:

- 1. Proposed Resolution
- 2. Existing Conditions Photos
- 3. Surrounding Land Uses Map
- 4. Project Site and Floor Plans
- 5. Development Review Design Guidelines (DRDGS)
- 6. Public Hearing Notice/Vicinity Map
- 7. CCC Fire Conditions of Approval
- 8. Odor Management Plan dated October 9, 2024
- 9. Standard Conditions of Approval

Prepared by: Maurice Brenyah-Addow, Senior Planner

## BEFORE THE ZONING ADMINISTRATOR OF THE CITY OF PITTSBURG

In the Matter of:

Granting Administrative Use Permit (AUP) and ) Design Review (DR) approval to establish a ) commercial seafood store and processing ) operation (Light Industrial use) and make minor) exterior and site enhancements to existing ) commercial building located at 2685 E. Leland ) Road. AP-24-0085; APN: 088-152-017 )

Resolution No.

The Zoning Administrator DOES RESOLVE as follows:

### Section 1. Background

- A. On July 25, 2024, Wolfgang Croskey, on behalf of Fisherman's Catch, filed Administrative Use Permit (AUP) and Design Review (DR) to establish a commercial seafood store and processing operation in the IL-O zone and make minor exterior and site enhancements to existing commercial building located at 2585 E. Leland Road. AP-24-0085; APN: 088-152-017.
- B. The proposed project is governed by the policies, development standards, and guidelines contained in the Pittsburg General Plan, Pittsburg Municipal Code (PMC) Title 18 (Zoning), the City of Pittsburg Development Review Design Guidelines (DRDG; Planning Commission Resolution No. 9864).
- C. On August 13, 2024, a Notice of Intent to conduct a Zoning Administrator hearing for this project was included on the Planning Commission agenda consistent with PMC section 18.10.050.
- D. Design review approval can be granted by the Zoning Administrator pursuant to PMC section 18.10.050 only after a determination is made that the proposed project is consistent with PMC section 18.36.200.
- E. This project is categorically exempt from the requirements of the California Environmental Quality Act (CEQA) under Class 1, "Existing Facilities" of the state CEQA Guidelines section 15301.

Section 2. Findings

<u>Use Permit:</u> Pursuant to PMC section 18.16.040, in order to approve the Use Permit for the facility, the Zoning Administrator must find that the project:

- A. is in accord with the objective of the Zoning Ordinance, the purposes of the land use district in which it is located and is appropriate to the specific location in that the IL-O (Limited Industrial with Limited Overlay District) to allow for limited food processing, custom manufacturing and light industrial uses are consistent with the 2040 General Plan Land Use Map which changed the GP designation from Industrial to Employment Center Industrial (ECI);
- B. is not detrimental to the health, safety, and general welfare of the city, in that conditions of approval have been added to address all potential negative impacts;
- C. will not adversely affect the orderly development of property within the city, in that it does not modify the existing structure but rather involves improvements to the existing building in the form of new paint, signage and landscaping and other site improvements;
- D. will not adversely affect the preservation of property values and the protection of the tax base and other substantial revenue sources within the city, in that the conditions of approval addresses all potential negative impacts such as odor and trash disposal;
- E. is consistent with the objectives, policies, general land uses and programs specified in the general plan and applicable specific plan, in that custom manufacturing and light industrial uses are consistent with the 2040 General Plan Land Use Map which changed the General Plan designation from Industrial to Employment Center Industrial (ECI);
- F. will not create a nuisance or enforcement problem within the neighborhood, in that conditions of approval have been added to minimize negative impacts from the operations;
- G. will not encourage marginal development within the neighborhood, in that no expansion to the structure is involved. Exterior enhancements include new paint, parking lot restriping, new landscaping, new signage, and security cameras;
- H. will not create a demand for public services within the city beyond that of the ability of the city to meet in the light of taxation and spending restraints imposed by law, in that the light food processing and grocery store are not typically known to demand extra public services;
- I. is consistent with the city's approved funding priorities, in that the project is a privately funded enterprise; and,
- J. if located within the pedestrian commercial (CP) district, will support the goals of creating a vibrant, economically prosperous, visually interesting, and engaging pedestrian oriented atmosphere along the primary downtown corridor, in that the site is not located in the CP district.

### Design Review

- A. Based on all the information contained in the Planning Division files on this project, incorporated herein by reference and available for review in the Planning Division located at 65 Civic Avenue in Pittsburg, and based on application materials presented to the Zoning Administrator for review, the Zoning Administrator finds that:
  - 1. All recitals above are true and correct and are incorporated herein by reference.
  - 2. In accordance with the requirements of PMC 18.36.220(B), the proposed improvements:
    - a. Will conform with good taste, good design and in general contribute to the character and image of the City as a place of beauty, spaciousness, balance, taste, fitness, broad vistas, and high quality, in that the new establishment will occupy a currently vacant commercial building that is currently experiencing break-ins and blight issues. The new color scheme and new landscaping will enhance the appearance of the building by providing an attractive, refreshed exterior.
    - b. Will be protected against exterior and interior noise, vibrations and other factors that may tend to make the environment less desirable, in that the proposed new use is not expected to generate any significant exterior and interior noise, vibrations and other factors that may tend to make the environment less desirable.
    - c. Will have an exterior design and appearance that will not be of inferior quality as to cause the nature of the neighborhood to materially depreciate in appearance and value, in that the proposed project will improve and enhance an existing commercial property.
    - d. Will be in harmony with proposed developments on land in the general area, in that the exterior paint colors, landscaping and site improvements will coordinate with and compliment the surrounding buildings and neighboring developments.
    - e. Generally conform with the City's Development Review and Design Guidelines (DRDG); Planning Commission Resolution No. 9864 section IV.p in that the exterior paint color palate will be compatible with the rest of the existing building.

#### Section 3. Decision

A. Based on the findings set forth above, the Zoning Administrator hereby approves Design Review Application No. AP-24-0085, subject to the following conditions:

- 1. Conformity with Project Plans. The proposed commercial seafood store and processing operation and minor exterior and site enhancements to existing commercial building located at 2585 East Leland Road shall be constructed in substantial conformance with the project plans received by City Staff, and attached to this resolution as Exhibit A, except as may be hereinafter modified.
- 2. Operation of the approved uses in a manner inconsistent with this approval by the Zoning Administrator shall be grounds for revocation pursuant to PMC Section 18.28.
- 3. Hours of Operation. The hours of operation for the approved uses shall limited daily to 6:00 AM to 9:00 PM during busy seasons from December to February. In the off-season, operations will adjust to 6am-6pm.
- 4. An administrative use permit amendment shall be required prior to operation outside these hours.
- 5. Exterior Materials and Finishes. The exterior materials and finishes of the proposed structure shall be kept in a good state of repair and the exterior finish shall remain clean and well maintained.
- 6. Site Maintenance. The site shall be kept clean and free of all litter, debris, and refuse. The facility shall be maintained in a good condition at all times, including but not limited to accompanying equipment and fixtures.
- 7. Landscaping. The project shall install landscaping and irrigation as per the approved project plans. The landscape areas shall be maintained so as to remain in a healthy, thriving and weed free condition. Any dead or unhealthy plants shall be replaced with a similar species.
- 8. Signage. This resolution does not approve business or advertising signage. No permanent business signs or temporary, promotional, or event signs and banners may be placed on the site prior to application, review, and approval for a sign permit by the Planning Division.
- 9. Security Cameras. The applicant shall install security cameras around the site and shall cooperate with the Pittsburg Police Department to: a) install the cameras on-site and in the building in a quantity and at locations that optimize the safety of customers and employees on the property; and b) ensure that the Pittsburg Police Department establishes and is provided continuous access to live and recorded feed from the security cameras installed on-site.
- 10. Graffiti Removal: All graffiti shall be removed on any part of the property within 48 hours of its appearance.

Special Conditions

- 11. This approval only permits, cleaning, packing, storage and sales of seafood. No onsite cooking or boiling of seafood shall be permitted. All cooking shall occur off site as indicated in the odor management plan.
- 12. All organic waste from the operations shall be disposed of on a daily basis as per the waste disposal plan dated October 9, 2024. This waste disposal plan attached as (Attachment 8) dated October 9, 2024, shall be referenced and incorporated into the daily waste procedures for this project. The Community and Economic Development Department staff reserves the right to enforce these conditions pursuant to PMC Section 18.90 Compliance and Penalties. Only inorganic waste is permitted to be stored at the existing trash enclosure.
- 13. The proposed odor management plan (Attachment 8) dated October 9, 2024, shall be strictly adhered to and a copy shall be posted prominently within the facility for all worker and employees to review. The Community and Economic Development Department staff reserve the right to enforce these conditions pursuant to PMC Section 18.90 Compliance and Penalties.
- 14. Delivery shall only occur between the hours of 7:00 AM and 7:00 PM on weekdays. Delivery trucks shall be pre-instructed to avoid driving over the median located on East Leland Road
- 15. Sewer Lateral: The upper and lower 4" lateral sewer lines appear unsized for the type of facility. Upon verification by the Pittsburg Public Works Department, a six-inch lower and upper lateral pipe may be required. The facility may also need installation of a grease interceptor if determined as needed by the Pittsburg Public Works Department prior to commencement of operations.
- 16. Outdoor Dining Permits. Outdoor dining is not approved with this resolution. The applicant or business operators shall submit proposed outdoor furniture as part of separate outdoor dining permit applications for each business, which shall be subject to review and approval by the Community and Economic Development Department prior to installation and use.
- 17. Loitering. The business operator shall ensure that there is no loitering on the sidewalks, rear or side yards, or streets surrounding the business tenant space, or within the nearby parking lots, during operating hours and within one (1) hour of business closing. If the business operator observes loitering, the Pittsburg Police Department shall be notified immediately.
- 18. Peace and Order. The business operator shall be responsible for maintaining the peace and order on the premises. All necessary steps shall be taken to ensure that the customers refrain from incidents of violence that adversely impact the safety of the community. Should the business operator fail to control loitering, noise, public disturbances or incidents of violence, and in the event that the business necessitates an increased police presence, the Chief of Police may require the business owners to provide additional public safety measures, including but not limited to, video cameras,

additional exterior lighting, hiring licensed and bonded security guards approved by the Police Department, or such other measures as determined necessary by the Chief of Police. Any such required additional measures shall be at the business owner's/operator's sole expense.

- 19. Site Maintenance. The site and adjacent street and sidewalk shall be kept clean and free of all litter, debris, and refuse that may be generated from the operation of the business, at all times.
- 20. Waste: The business operator shall ensure that his/her employees bag and seal food/drink waste prior to placing it in the organic waste bins.
- 21. Tallow Bins. The business operator shall ensure that all tallow bin lids are inside the building, kept closed, and that they are maintained inside so as to avoid spillage, leaking, and/or overflowing.
- 22. Dry Clean-up Methods. The business operator shall practice dry clean-up methods for outdoor sidewalk and patio surface areas, in accordance with the guidelines established by the Bay Area Stormwater Management Agencies Association (BASMAA).
- 23. Disposal of Liquids. The business operator shall ensure that employees collect and dispose of water and cleaning liquids to the sanitary sewer, not the exterior storm drain inlets/catch basins.
- 24. Floor Mat Cleaning. The business owner shall not allow floor mats to be cleaned or rinsed outdoors.
- 25. Detergents and Degreasers. The business operator shall ensure that detergents and degreasers are never used in the process of outdoor cleaning.
- 26. Parking and Maneuvering. All outside parking stalls, maneuvering aisles, and designated parking areas shall be restriped and include all appropriate signage as required under the California Building Code (CBC).
- 27. Bicycle Parking. The project applicant shall install a minimum of 4 bicycle parking stalls as required by PMC Section 18.78.045 for the proposed project.

## Building Services Conditions

28. On the cover sheet, please indicate the building Design Codes applicable to this project. The City of Pittsburg has adopted and enforces the following building Design Codes: 2022 California Administrative Code (CAC), 2022 California Building (CBC), 2022 California Historical Building Code (CHBC), 2022 California Existing Building Code (CEBC), 2022 California Green Building Standards Code (CGBSC), 2022 California Mechanical Code (CMC), 2022 California Plumbing Code (CPC), 2022

California Electrical Code (CEC), 2022 California Energy Code (CEC Part 6), 2022 California Fire Code and the Pittsburg Municipal Code (RMC). Reference CRC Sec. R106.

- 29. On the cover sheet, please verify the Drawing Index includes all plan sheets. And design criteria. Reference CRC section R106
- 30. The preparation of plans and documents shall be prepared by a registered design professional where required per statutes of the City of Pittsburg where the project is being built. The licensed architect or engineer shall affix a stamp to the plans as evidence of the person's responsibility for the documents. Licensed Mechanical, Plumbing and Electrical Contractors may design the systems that they are to install. On plans not required to have a design professional and are designed by a plans designer shall sign every sheet.
- 31. The Site Plan shall show the size and location of the new construction and existing structures on the site and distances from lot lines and other structures, and include where the residence ties into sewer, power and water from the street.
- 32. All supporting documents are included but are not limited to, truss plans and calculations with a letter of approval for the trusses by the EOR. Energy calculations and all other pertinent information for this project.

#### Standard Conditions

- 33. Standard Conditions of Development. The Standard Conditions of Development as adopted by the Pittsburg Planning Commission by Resolution No. 8931 (See Attachment 9 of Staff Report) shall apply as conditions of approval for this project as applicable. Where there is a conflict between this resolution and the Standard Conditions of Development, this resolution shall govern.
- 34. Indemnification. Applicant agrees to indemnify, defend, and hold harmless the City, its officials, officers, employees, agents and consultants from any and all administrative, legal or equitable actions or other proceedings instituted by any person challenging the validity of this project approval, subsequent project approval, or other action arising out of, or in connection with, this project approval. The parties shall cooperate in defending such action or proceeding. The parties shall use reasonable efforts to select mutually agreeable defense counsel but, if the parties cannot reach agreement, City may select its own legal counsel at applicant's sole cost and expense. Applicant may select its own legal counsel to represent applicant's interests at applicant's sole cost and expense. Applicant shall pay for City's costs of defense, whether directly or by timely reimbursement to City on a monthly basis. Such costs shall include, but not be limited to, all court costs and attorneys' fees expended by City in defense of any such action or other proceeding, plus staff and City Attorney time spent responding to and defending the claim, action or proceeding.


- 35. Other Agency Requirements. The applicant shall comply with all of the requirements of the Community and Economic Development Department (including the Planning, Engineering and Building Divisions), and external; agencies including Contra Costa County Fire Protection District, and all applicable local, state, and federal agencies (See attached conditions of approval from CCCFPD, DTSC and CCHS) (See Attachments). It is the responsibility of the applicant to contact each local, state, or federal agency for requirements that may pertain to this project.
- 36. Expiration of Approval. This approval will expire on October 9, 2025, unless the improvements noted herein are diligently pursued to completion, or unless a written request for extension is filed with the Planning Division prior to the expiration date and is subsequently approved by the Zoning Administrator.

#### Section 4. Effective Date

This resolution shall take effect immediately upon adoption of this resolution.

The foregoing resolution was passed and adopted the <u>9<sup>th</sup></u>day of <u>October 2024</u>, by the Zoning Administrator of the City of Pittsburg, California.

JOHN L. FUNDERBURG III ZONING ADMINISTRATOR

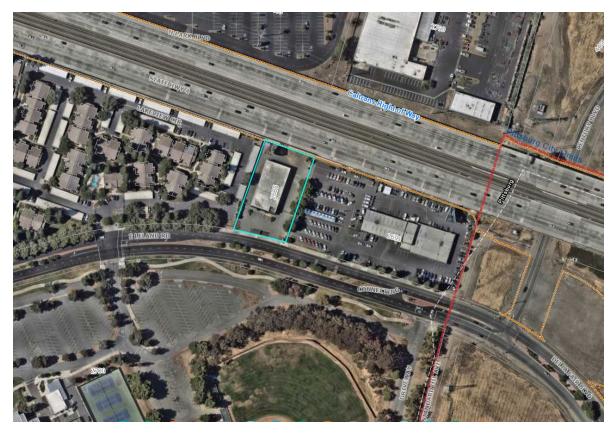

Aerial view of subject site and adjacent properties



Street view of subject site



Partial view looking northwest towards adjacent apartment complex



Partial view looking northeast towards adjacent car dealeship



View across the street looking southwest at Los Medanos Community College campus





East side of subject site showing maneuvering aisle and parking areas





West side of subject site showing driveway exit, maneuvering aisle and parking areas

### ATTACHMENT 3 - Surrounding Land Uses map

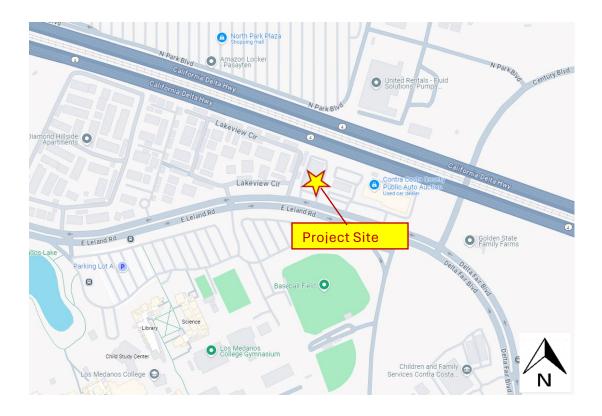

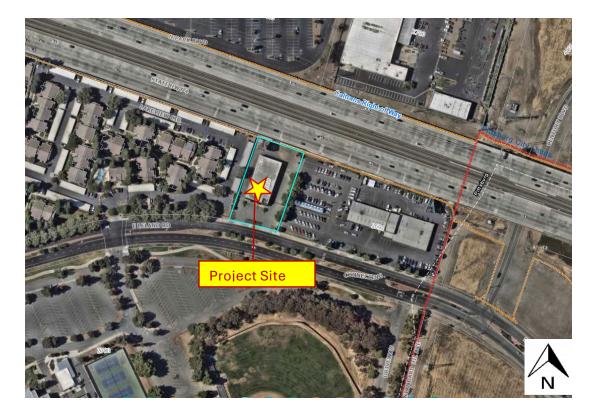

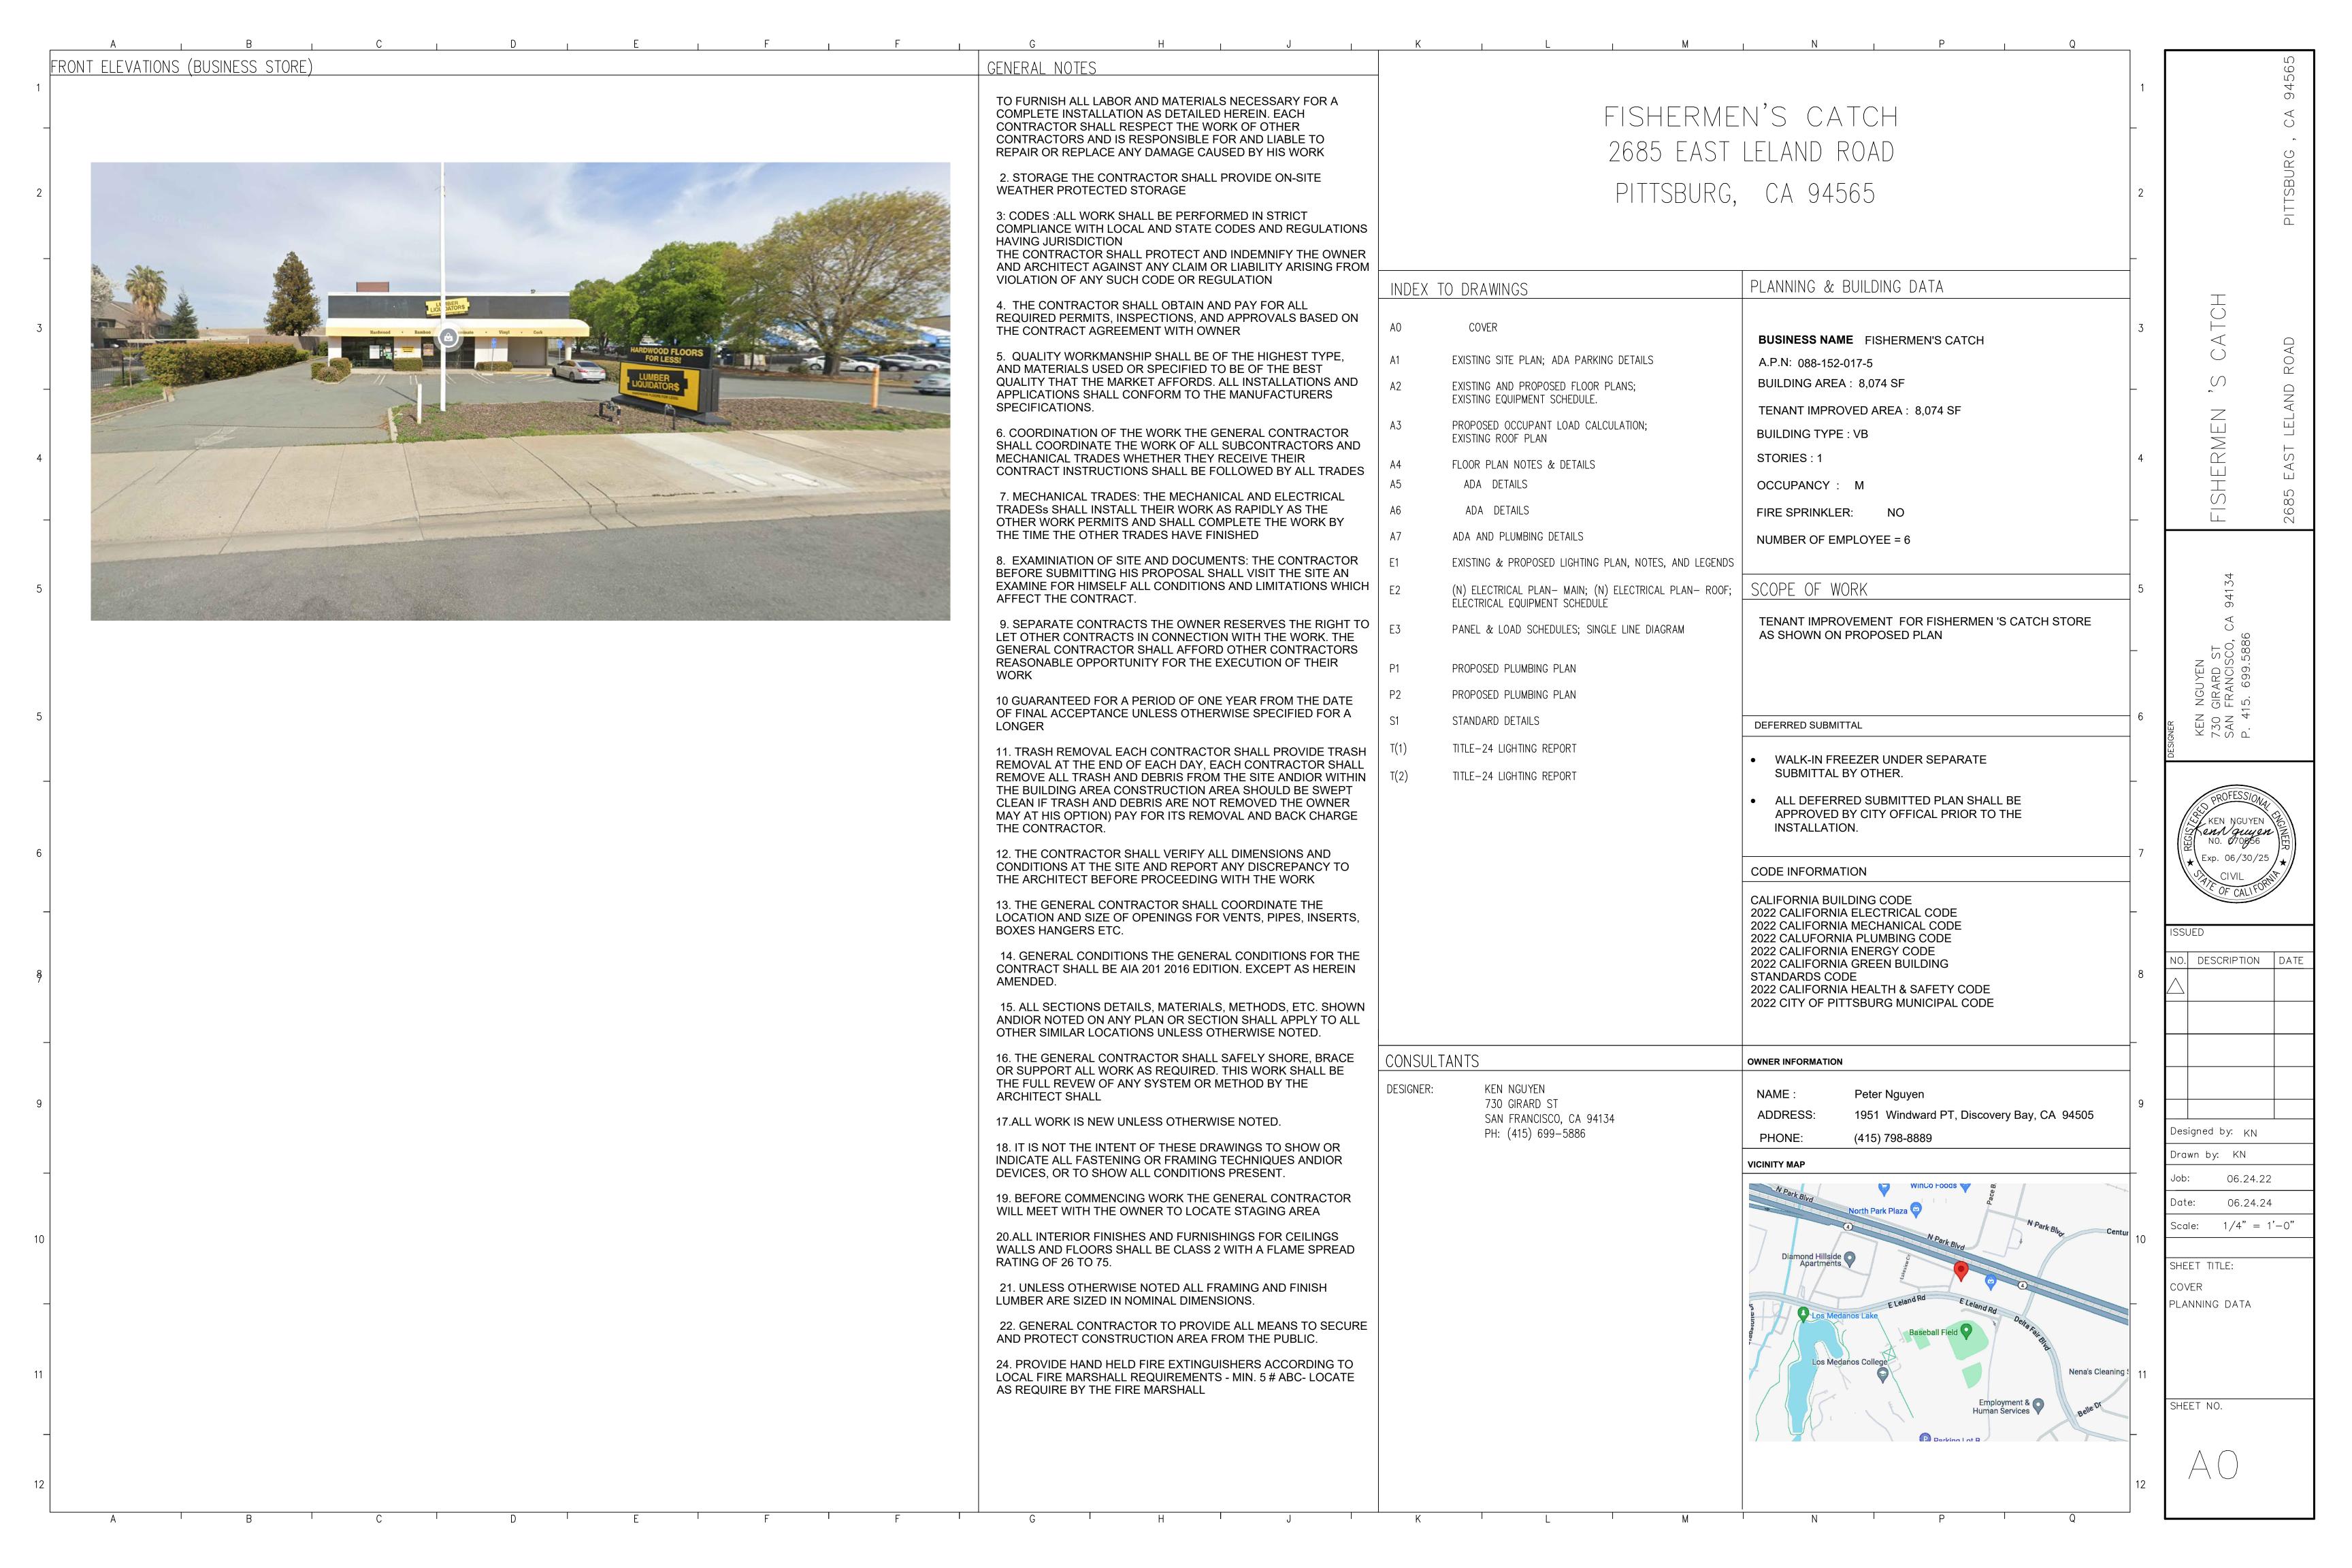

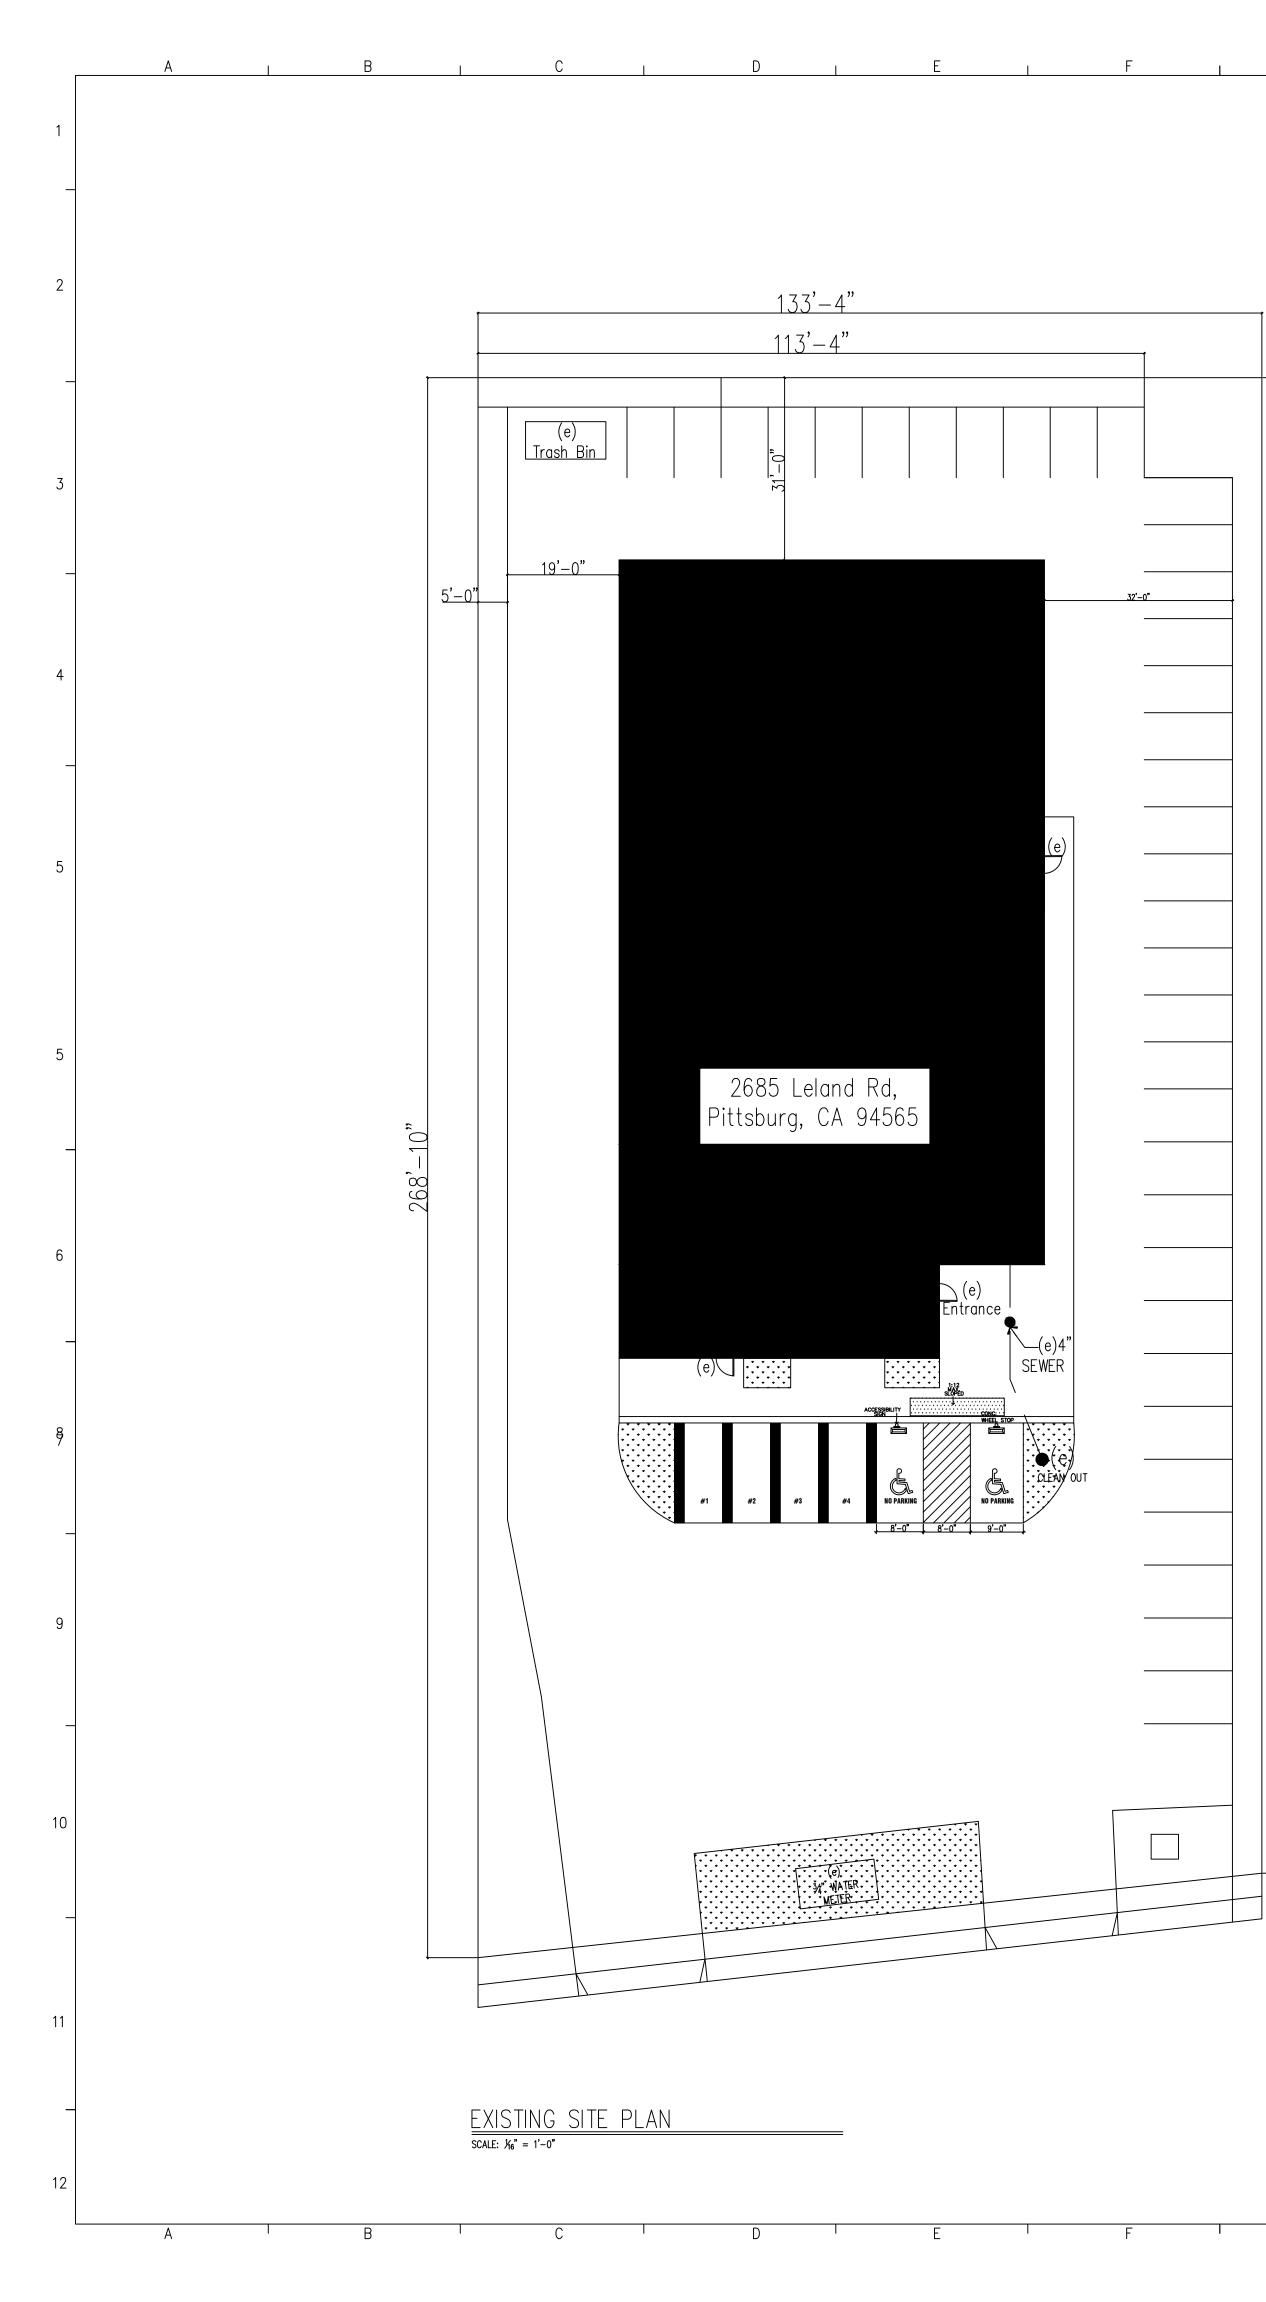



Н

K

J

L

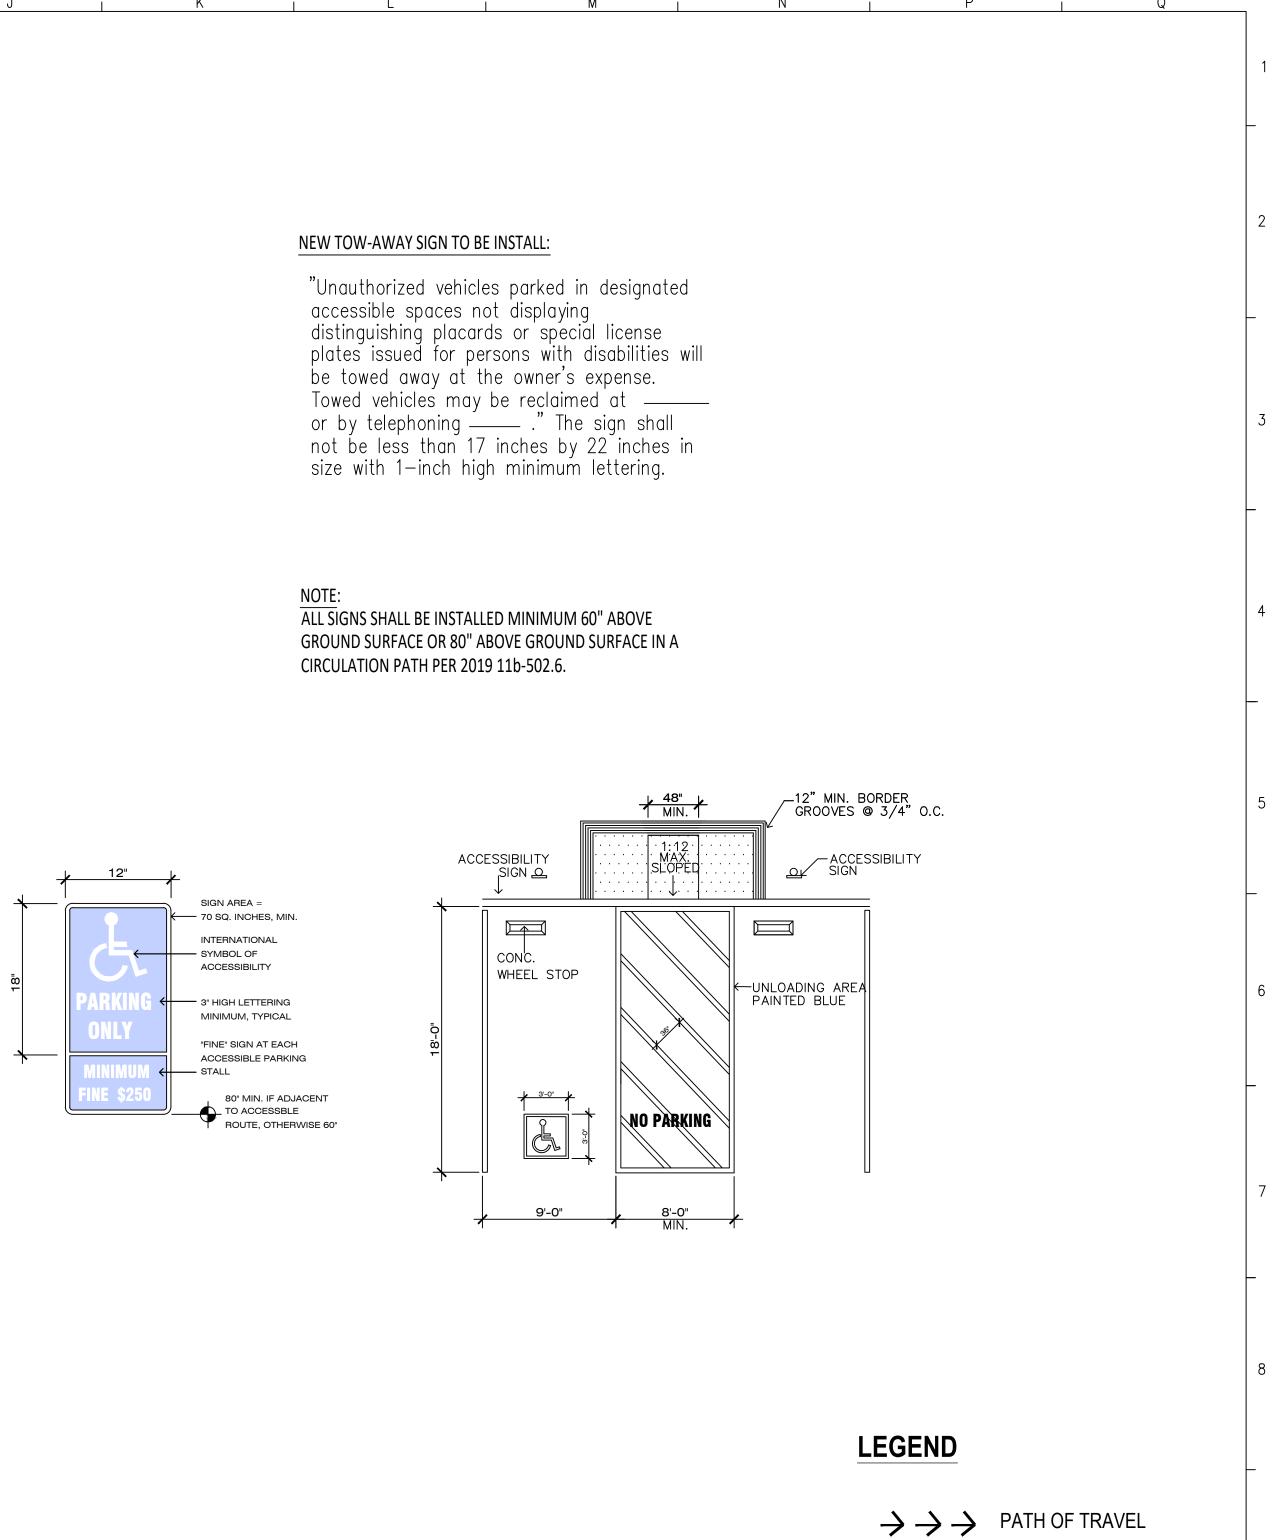

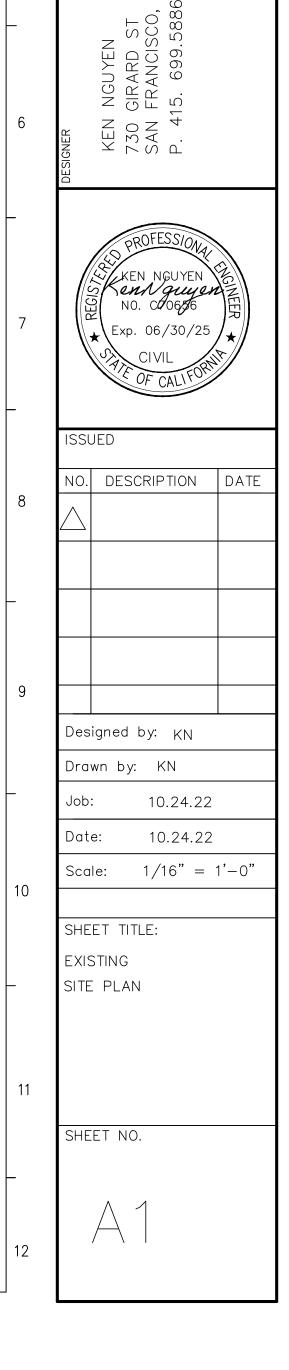

СA

•

PITTSBURG

ROAD

AND

Ш

2685

CATCH

 $\tilde{(}$ 

FISHERMEN

M

 $\triangleleft$ 


Õ


EXISTING

NEW

(E)

(N)

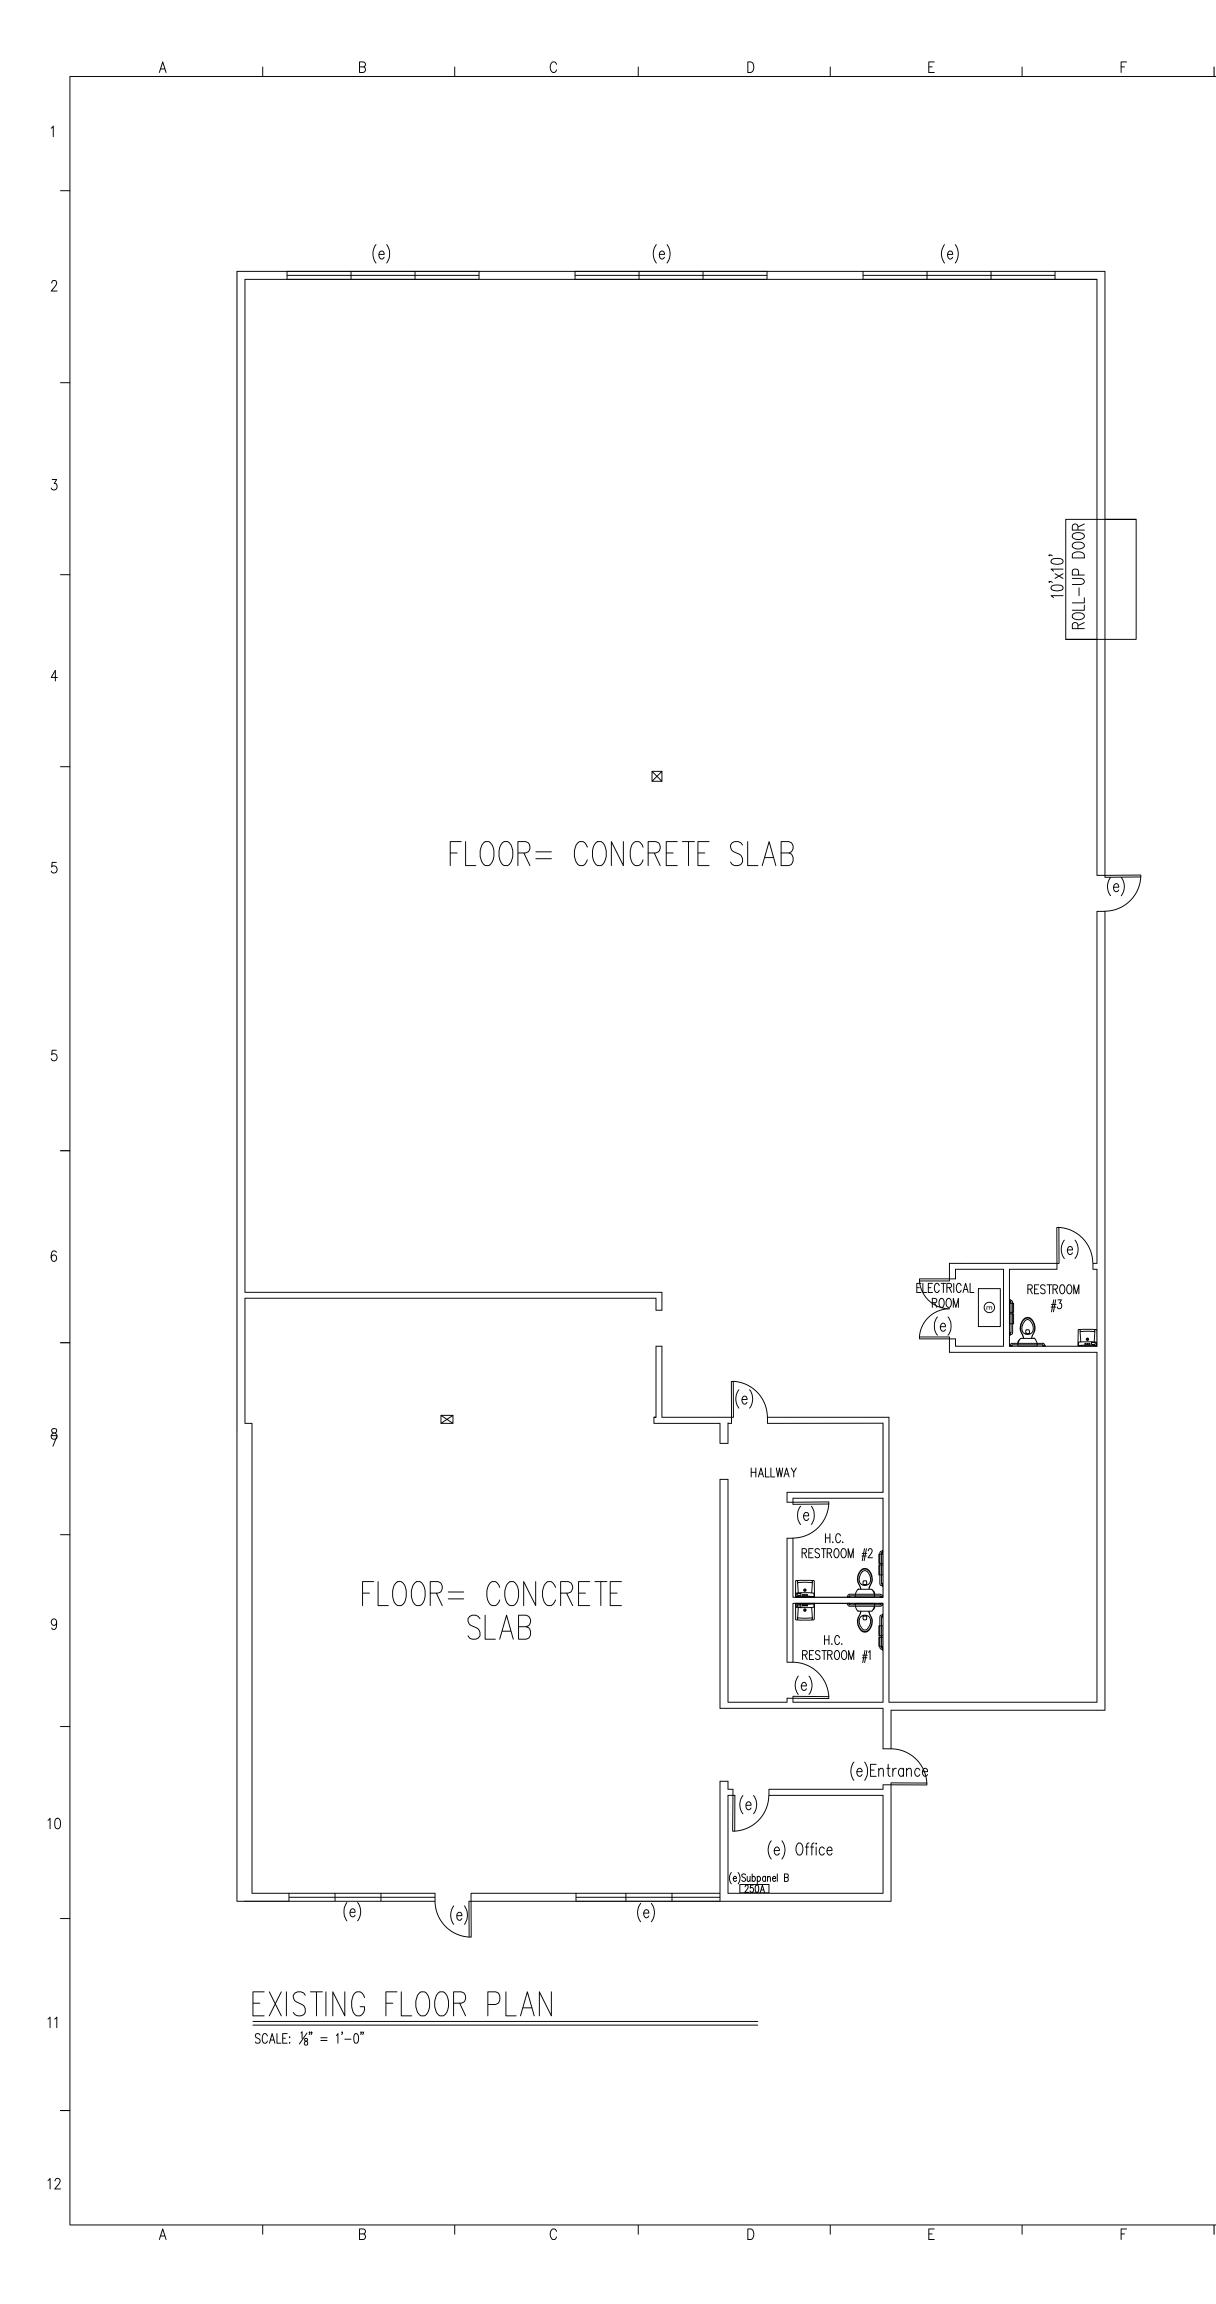

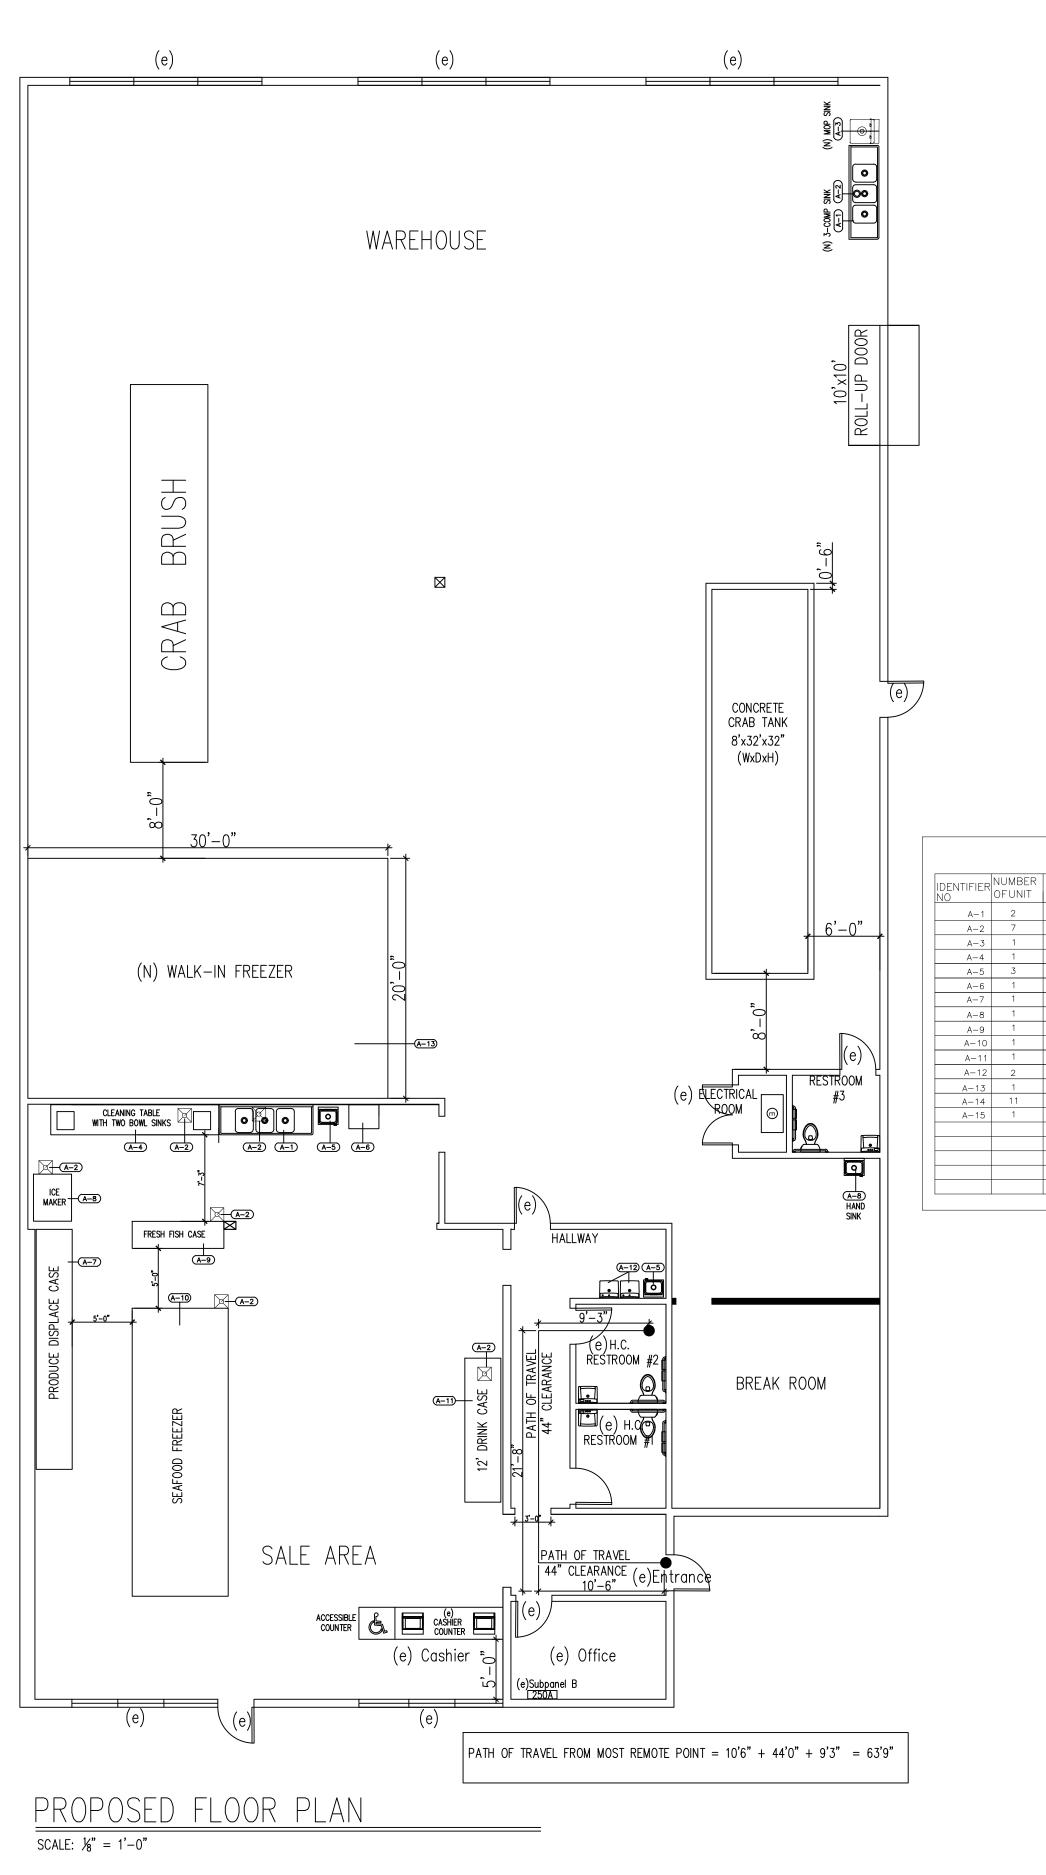


\_\_\_\_\_

	EQUIPTM	IENT SCHEDULE		
2	UNIT DESCRIPTION	DXWXH	MODEL NUMBER	POWER
	3-Compartment Sink	30"x8'x36"	Regency #600S3162018G	
	Floor Sink			
	Mop Sink			
	Cleaning Table With Two Bowl Sinks At End	30"x168"x36"	142-0793 14	
	Hand Sink Wall Mount With Backsplash	18"x18"x36"	Regency # 600HSMSE1818	
	Live Fish Tank	30"x		
	Produce Displace Case	44 3/8"x12'x68 1/4"	Hussmann IC3SL_012517	120V/60/10 ; 1.42A; 105W
	Hoshizaki Ice Machine	4'x3'	F-2001MRH3	208-230/60/3; 400W
	Fresh Fish Case	4'x12'x5'	Hussmann DSF-12-REM	115V/60/ <b>/</b> 0; 16A
	Sea Food Freezer	8'x24'x24"	OWEZV ; Serial No. 116499	120V/60/1⊅; 0.440A
	True Refrigeration — Drink Case	29 5/8"	xc716-69/8-1027805/8"	115V/60/ <b>/</b> 0 ; 7.3A; 1/2HP
	Existing Water Fountain			
	Walk-in Cooler (DEFERRED UNDER SEPARATE PERMIT)		CUSTOM COOLER	120V/60/1 <b>/</b> 0; 3A
	ELECTRICAL WATER HEATER		SR-20L/208-P	208V/60/1Ø; 4,160W, 20A
	EXISTING AC UNIT		RGH090HDCAOAAAA	208V/230V/60/30 <b>/</b> 45A

М

65 S 0. СA ( ) CATCH ROAD  $\mathbf{\hat{n}}$ AND FISHERMEN \_\_\_\_\_ AST L 2685 KEN NG 730 GIF SAN FR P. 415. KEN NGUYEN SKenn guyen SQ NO. 070856 Exp. 06/30/25 ISSUED NO. DESCRIPTION DATE Designed by: KN Drawn by: KN 06.24.24 Job: 06.24.24 Date: Scale: 1/8" = 1'-0"10 SHEET TITLE: EXISTING AND PROPOSED FLOOR PLANS; EQUIPMENT SCHEDULE SHEET NO. A212

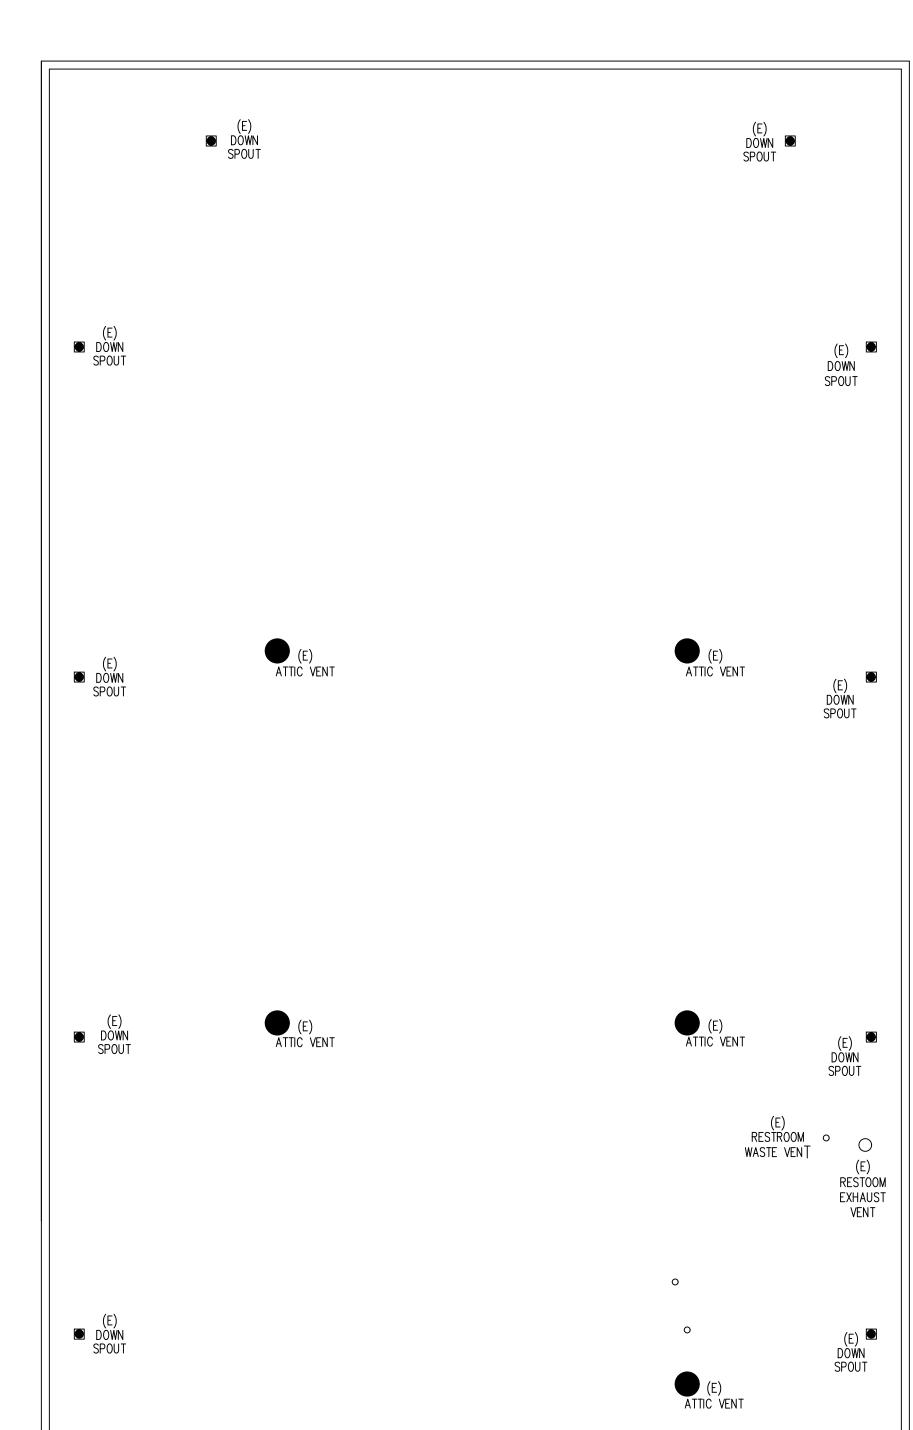

(E) ATTIC VENT (E) 50A, 30 Disconnect (E) HVAC



1

3


5

9

10

11

12

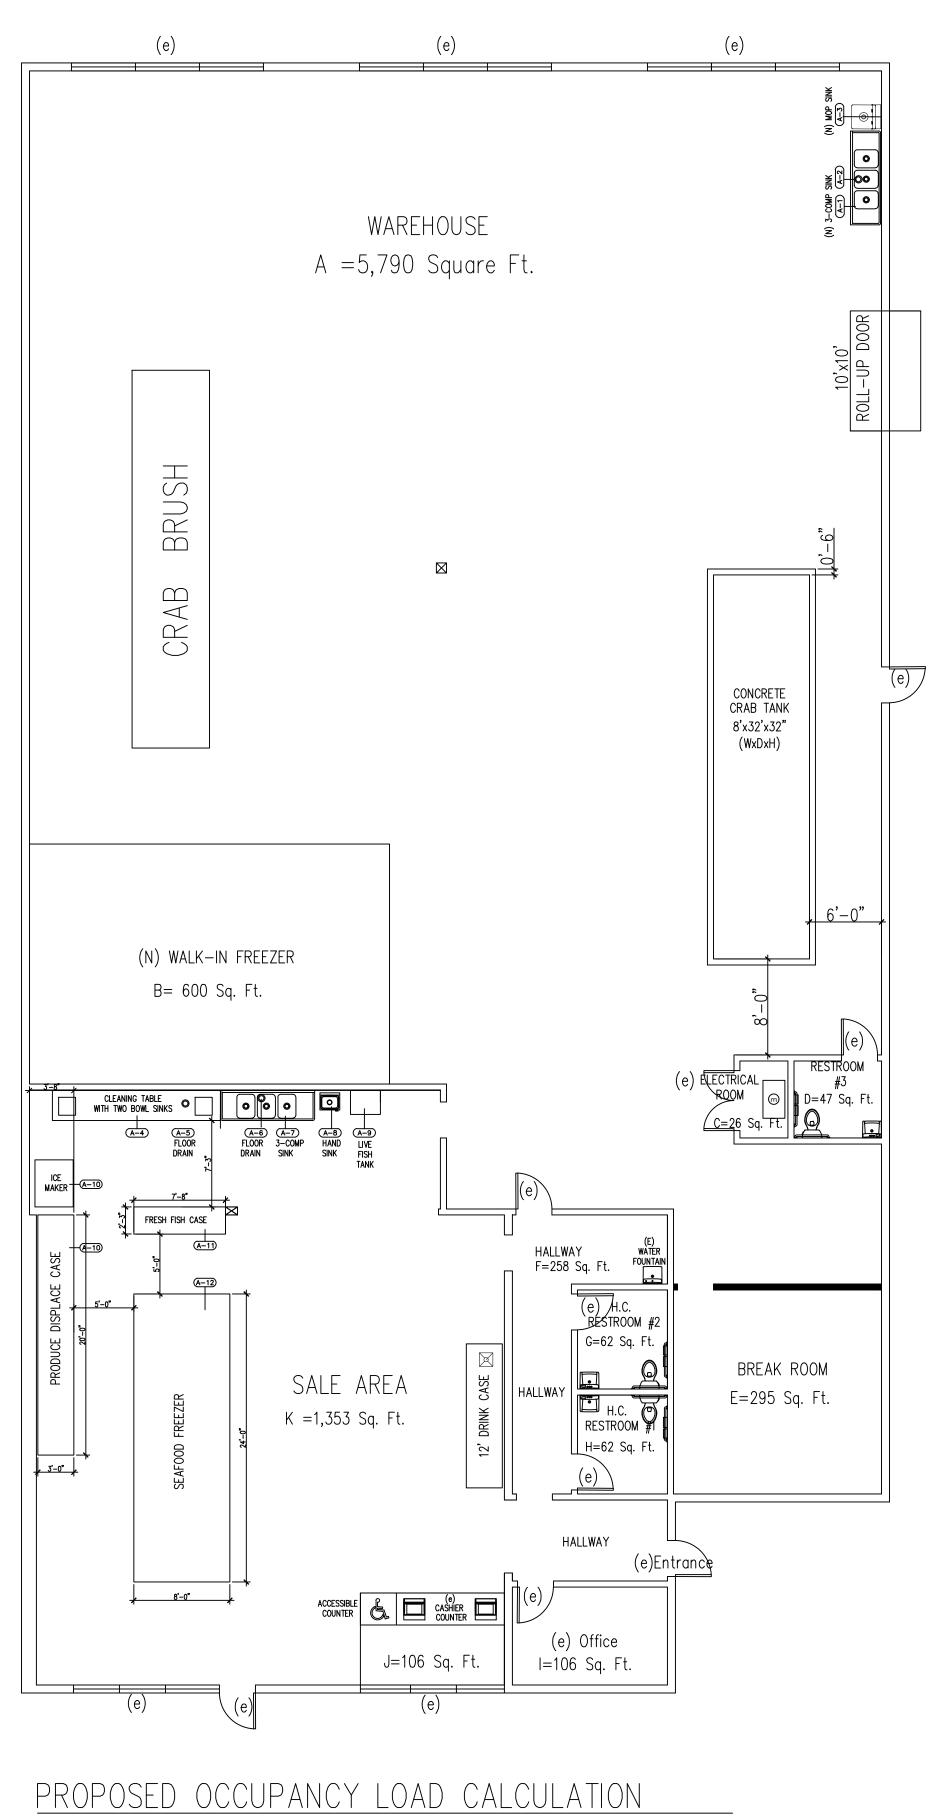

SCALE:  $\frac{1}{8}$ " = 1'-0"


		'S CATCH
3		CATCH
3		CATCH
3		CATCH
		CATC
4		$\langle \rangle$
4		
4		
4		$\leq$
		SHERMEN
5		94134
		CA 94
CODE SUMMARY		
		N NO O CIR N FR A 15
NUMBER OF OCCUPANTS (SEE SHEET 3.1 FOR CALC.)         35         • Contractor to verify field dimensions, conditions, etc., and bring any discrepancies to Liberty Construction prior to starting any construction prior to starting any construction prior or starting any construction prior prior – construction meetings .         6	LER	KEN 730 SAN
MININUM # OF EXITS REQUIRED 2 • All dimension are to face of studs	DESIGNER	
MAX. ALLOWED LENGTH OF COMMON PATH OF EGRESS       100 FEET         ACTUAL MAX. LENGTH PATH OF EXIT ACCESS       63'-9"	DE	

AREA	AREA (SQ.FT.)	OCCUPANT LOAD FACTOR	OCCUPAN LOAD
"A" (WAREHOUSE)	5,159	100	6 *
"B" (WALK-IN FREEZER)	600	100	1
"C" (UTILITY ROOM)	26	100	1
"D" (RESTROOM)	47	100	1
"E" (BREAKROOM)	295	100	3
"F" (HALLWAY)	258	100	3
"G" (H.C. RESTROOM 2)	62	100	1
"H" (H.C. RESTROOM 1)	62	100	1
"I" (OFFICE)	106	100	2
"J" (CASHIER AREA)	106	100	2
"K" (SALE AREA)	1,353	100	14
TOTAL OCCUPANT LOAD			35

5		r 0, CA 94134 866	
6	DESIGNER	KEN NGUYEN 730 GIRARD ST SAN FRANCISCO, CA 94134 P. 415. 699.5886	
- 7	. DEVIO	PROFESSIONAL KEN NGUYEN NO. 070636 Exp. 06/30/25 CIVIL VIE OF CALLFORM	FIGHER *
	ISSI	JED	
0	NO.	DESCRIPTION	DATE
8	$\bigtriangleup$		
9			
		ianad by:	
		igned by: KN	
_	Job	wn by: KN : 06.24.24	
		e: 06.24.24	
		le: $1/8" = 1'$	-0"
10		.,	-
-	PRC LOA	ET TITLE: POSED OCCUPAN D CALCULATION STING ROOF PLAN	·
11			
_	SHE	ET NO.	
12		A3	

PITTSBURG, CA 94565

2685 EAST LELAND ROAD

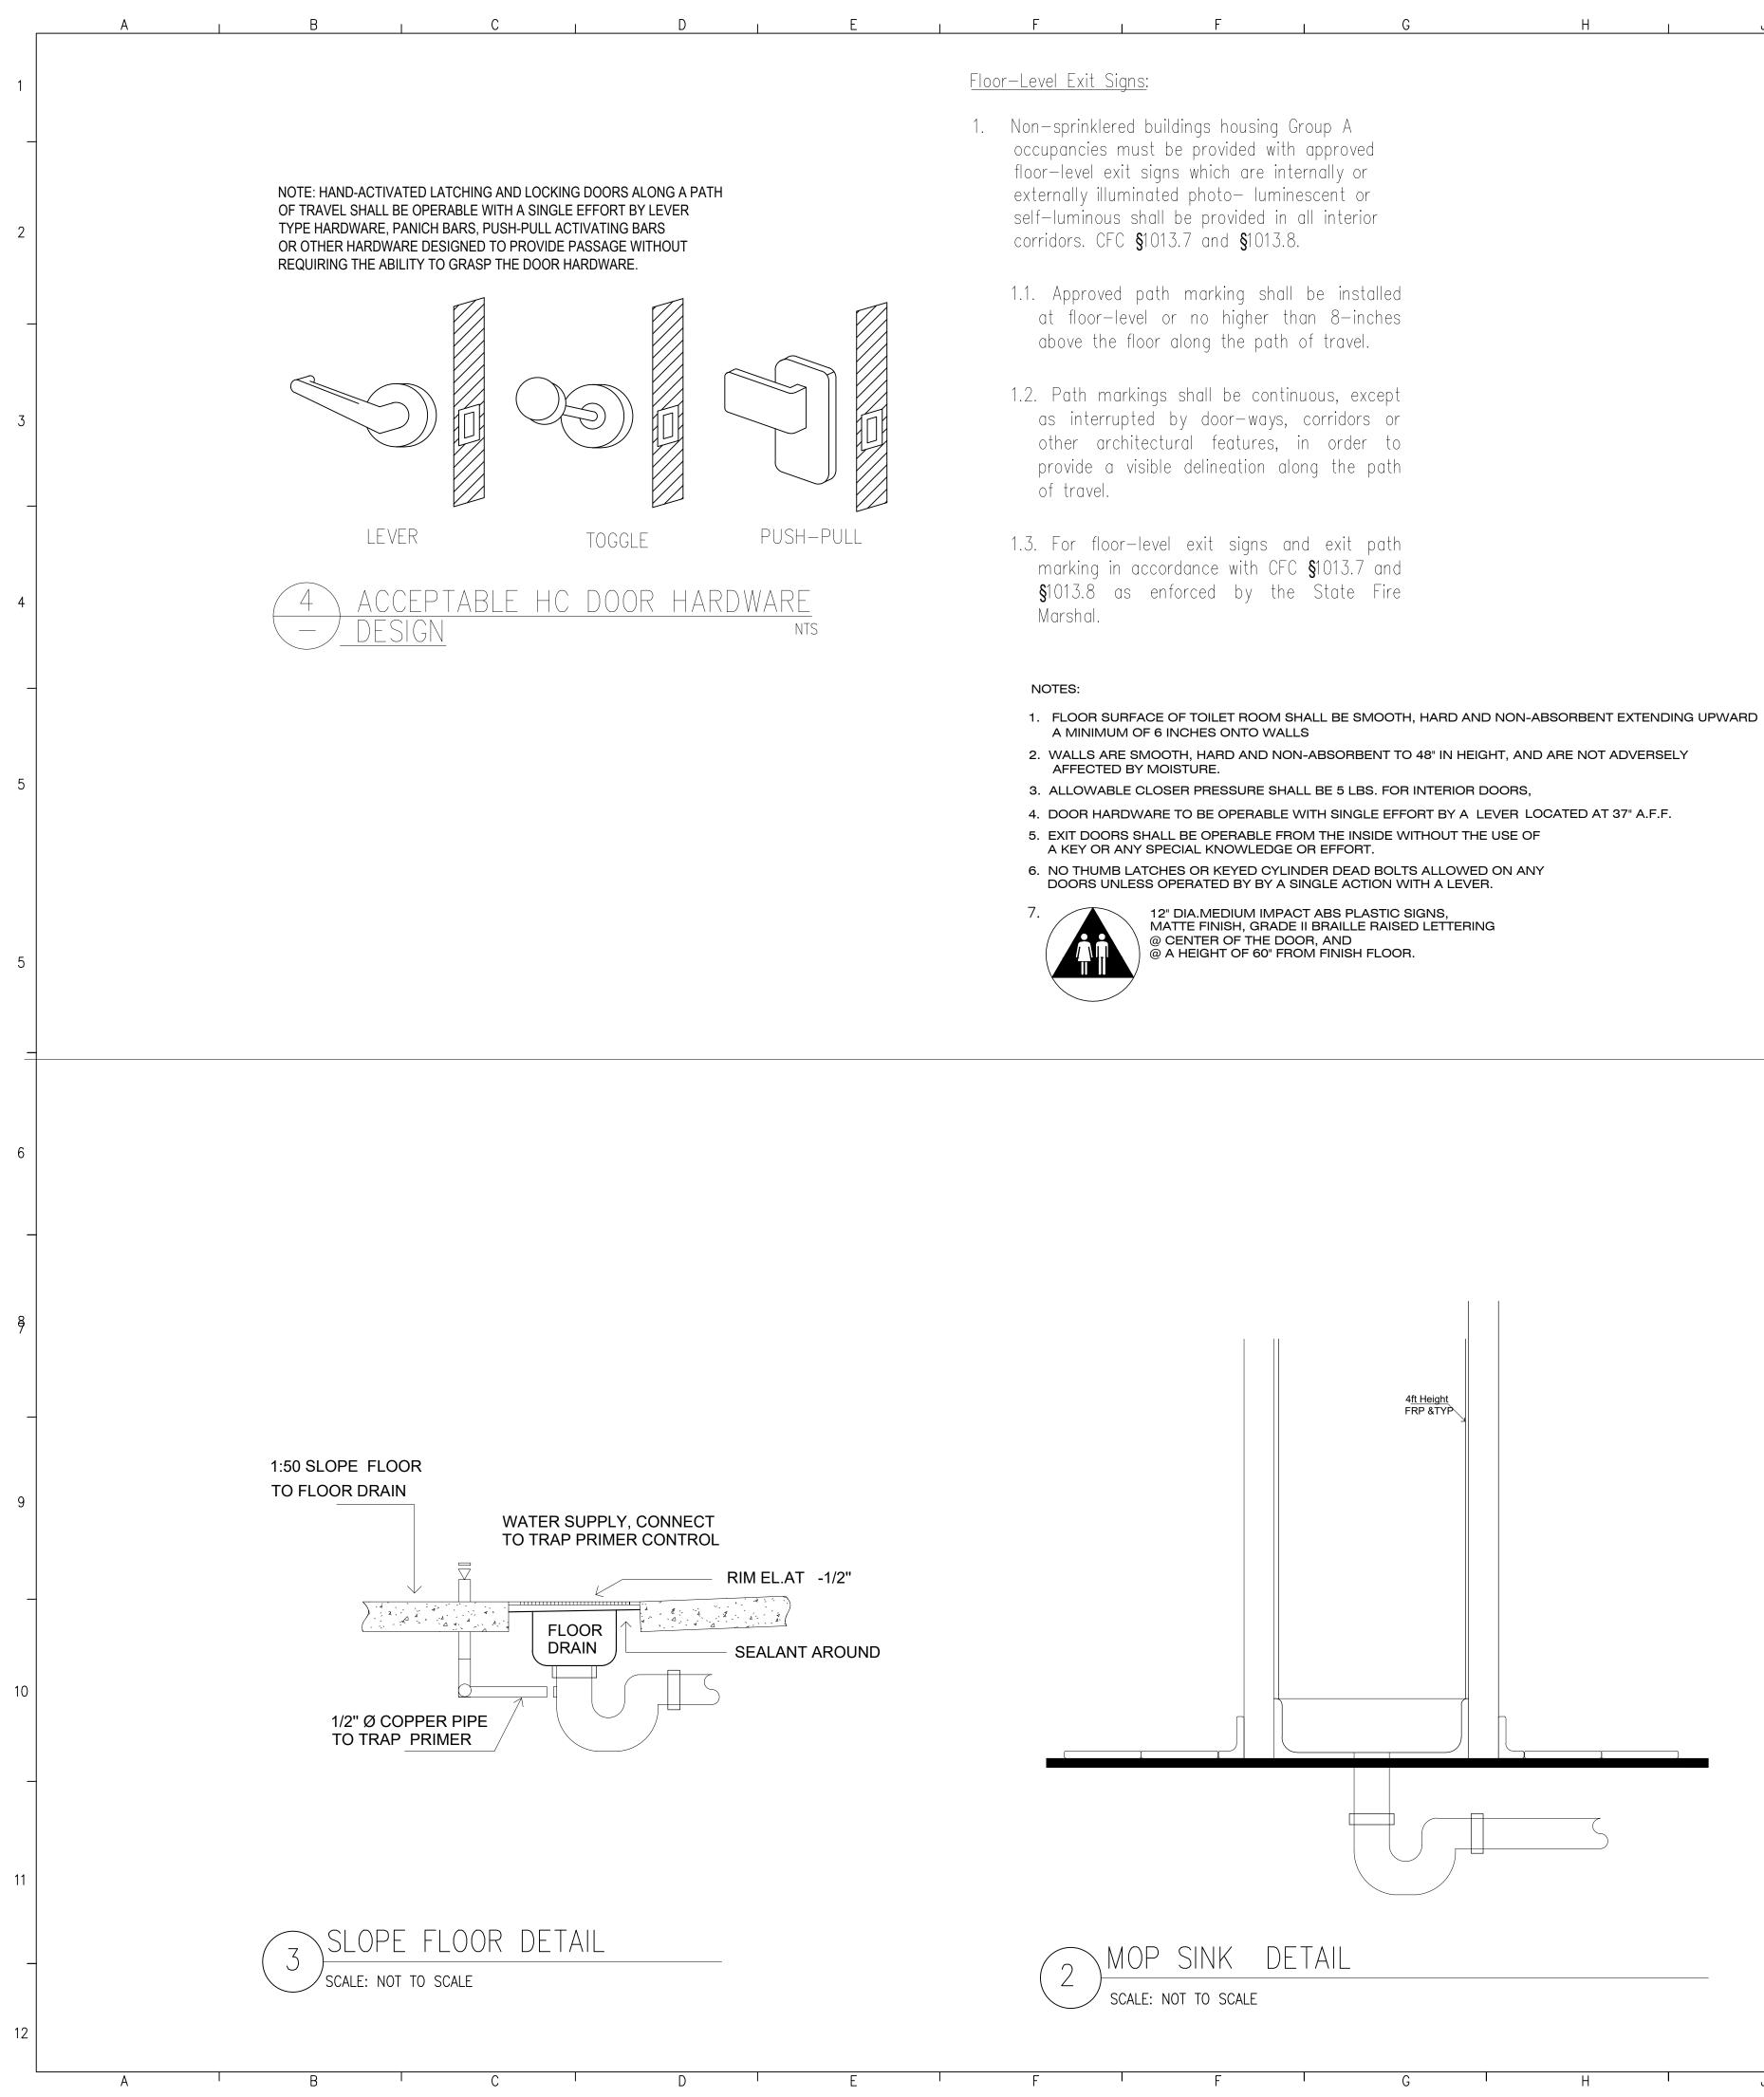

\_\_\_\_ 1/2" TRAP PRIM DOMESTIC C AT 1 - 1/2" D(/ TRAP PRIME PRODUCTS DISTRINUTIO - WALL, PROV PANEL. COOI AND G.C FOF 1/2" TRAP PF FLOOR DR -FLOOR SLAB SLEEVE THRU SLAB



<u>CODE SUMMARY</u>

NUMBER OF OCCUPANTS (SEE SHEET 3.1 FOR CALC.)	
MINIMUM EXIT SEPARATION	
MININUM # OF EXITS REQUIRED	
MAX. ALLOWED LENGTH OF COMMON PATH OF EGRESS	
ACTUAL MAX. LENGTH PATH OF EXIT ACCESS	

K

NOTES :


1. ALL DOOR WIDTH TO BE 36 INCHES MIN. TO PROVIDE REQUIRED 32


2. ALL SWITCHES, CONTROLS, THERMOSTATS, ETC. ARE INSTALLED M


3. THERE WILL BE NO NEW EQUIPMENTS WEIGHT MORE THAN 400# AN


WEIGHT MORE THAN 20# MOUNTED OR SUSPENDED FROM ROOF, 4. THE SCOPE OF WORK WILL INCLUDE ANY NECESSARY ACCESSIBILIT

L I	M	N I P I Q		
			1	Ą
ET 3.1 FOR CALC.)	35 N/A	<ul> <li>Contractor to verify field dimensions, conditions, etc., and bring any discrepancies to Liberty Construction prior to starting any constructioand/or pre - construction meetings .</li> </ul>		URG , C
N PATH OF EGRESS	2 100 FEET	All dimension are to face of studs	2	PITTSBURG
IT ACCESS	63'-9"			Ц. Ц.
	CEILING, OR WALLS.		3	'S CATCH Road
			4	FISHERMEN 2685 e leland
			5	EN D ST CISCO, CA 94134 99.5886
			6	DESIGNER KEN NGUYEN 730 GIRARD ST SAN FRANCISCO, P. 415. 699.588
DOMESTIC AT 1 - 1/2" D	IMER SUPPLY COLD WATER LINE D(A, MAXIMUM. 		7	PROFESSION KEN NGUYEN SCH CALLFORNIT NO. 070636 Exp. 06/30/25 ★ CIVIL FOF CALLFORNIT
PRODUCTS DISTRINUTI WALL, PRO PANEL. COO AND G.C FO	ER VALVE SHALL BE PREC INC. MODEL PR - 500 ON UNIT MODEL #DU. WHE VIDE WITH 12" X 12" RECES ORDINATE WITH ARCHITEC OR FINISH TYPE.	EN LOCATED IN SSED ACCESS CTURAL PLANS	8	ISSUED NO. DESCRIPTION DATE
1/2" TRAP F		WALL TRENCH DRAIN FLOOR SLAB	9	Designed by: KN Drawn by: KN
HRU SLAB	SAME AS FLOOR DRAIN -		10	Job: 06.24.24 Date: 06.24.24 Scale: NTS SHEET TITLE:
	IN-LINE PRIMERS <sup>-</sup> W/ ACCESS PANEI	S FOR A PRESSURE DROP PRIMER. TO BE INSTALLED ABOVE CELLINGS ILS AS REQUIRED	11	FLOOR PLAN NOTES & DETAILS SHEET NO.
RAP PRIMER	DETAIL		_	A 4
CALE: NOT TO SCALE			12	A4

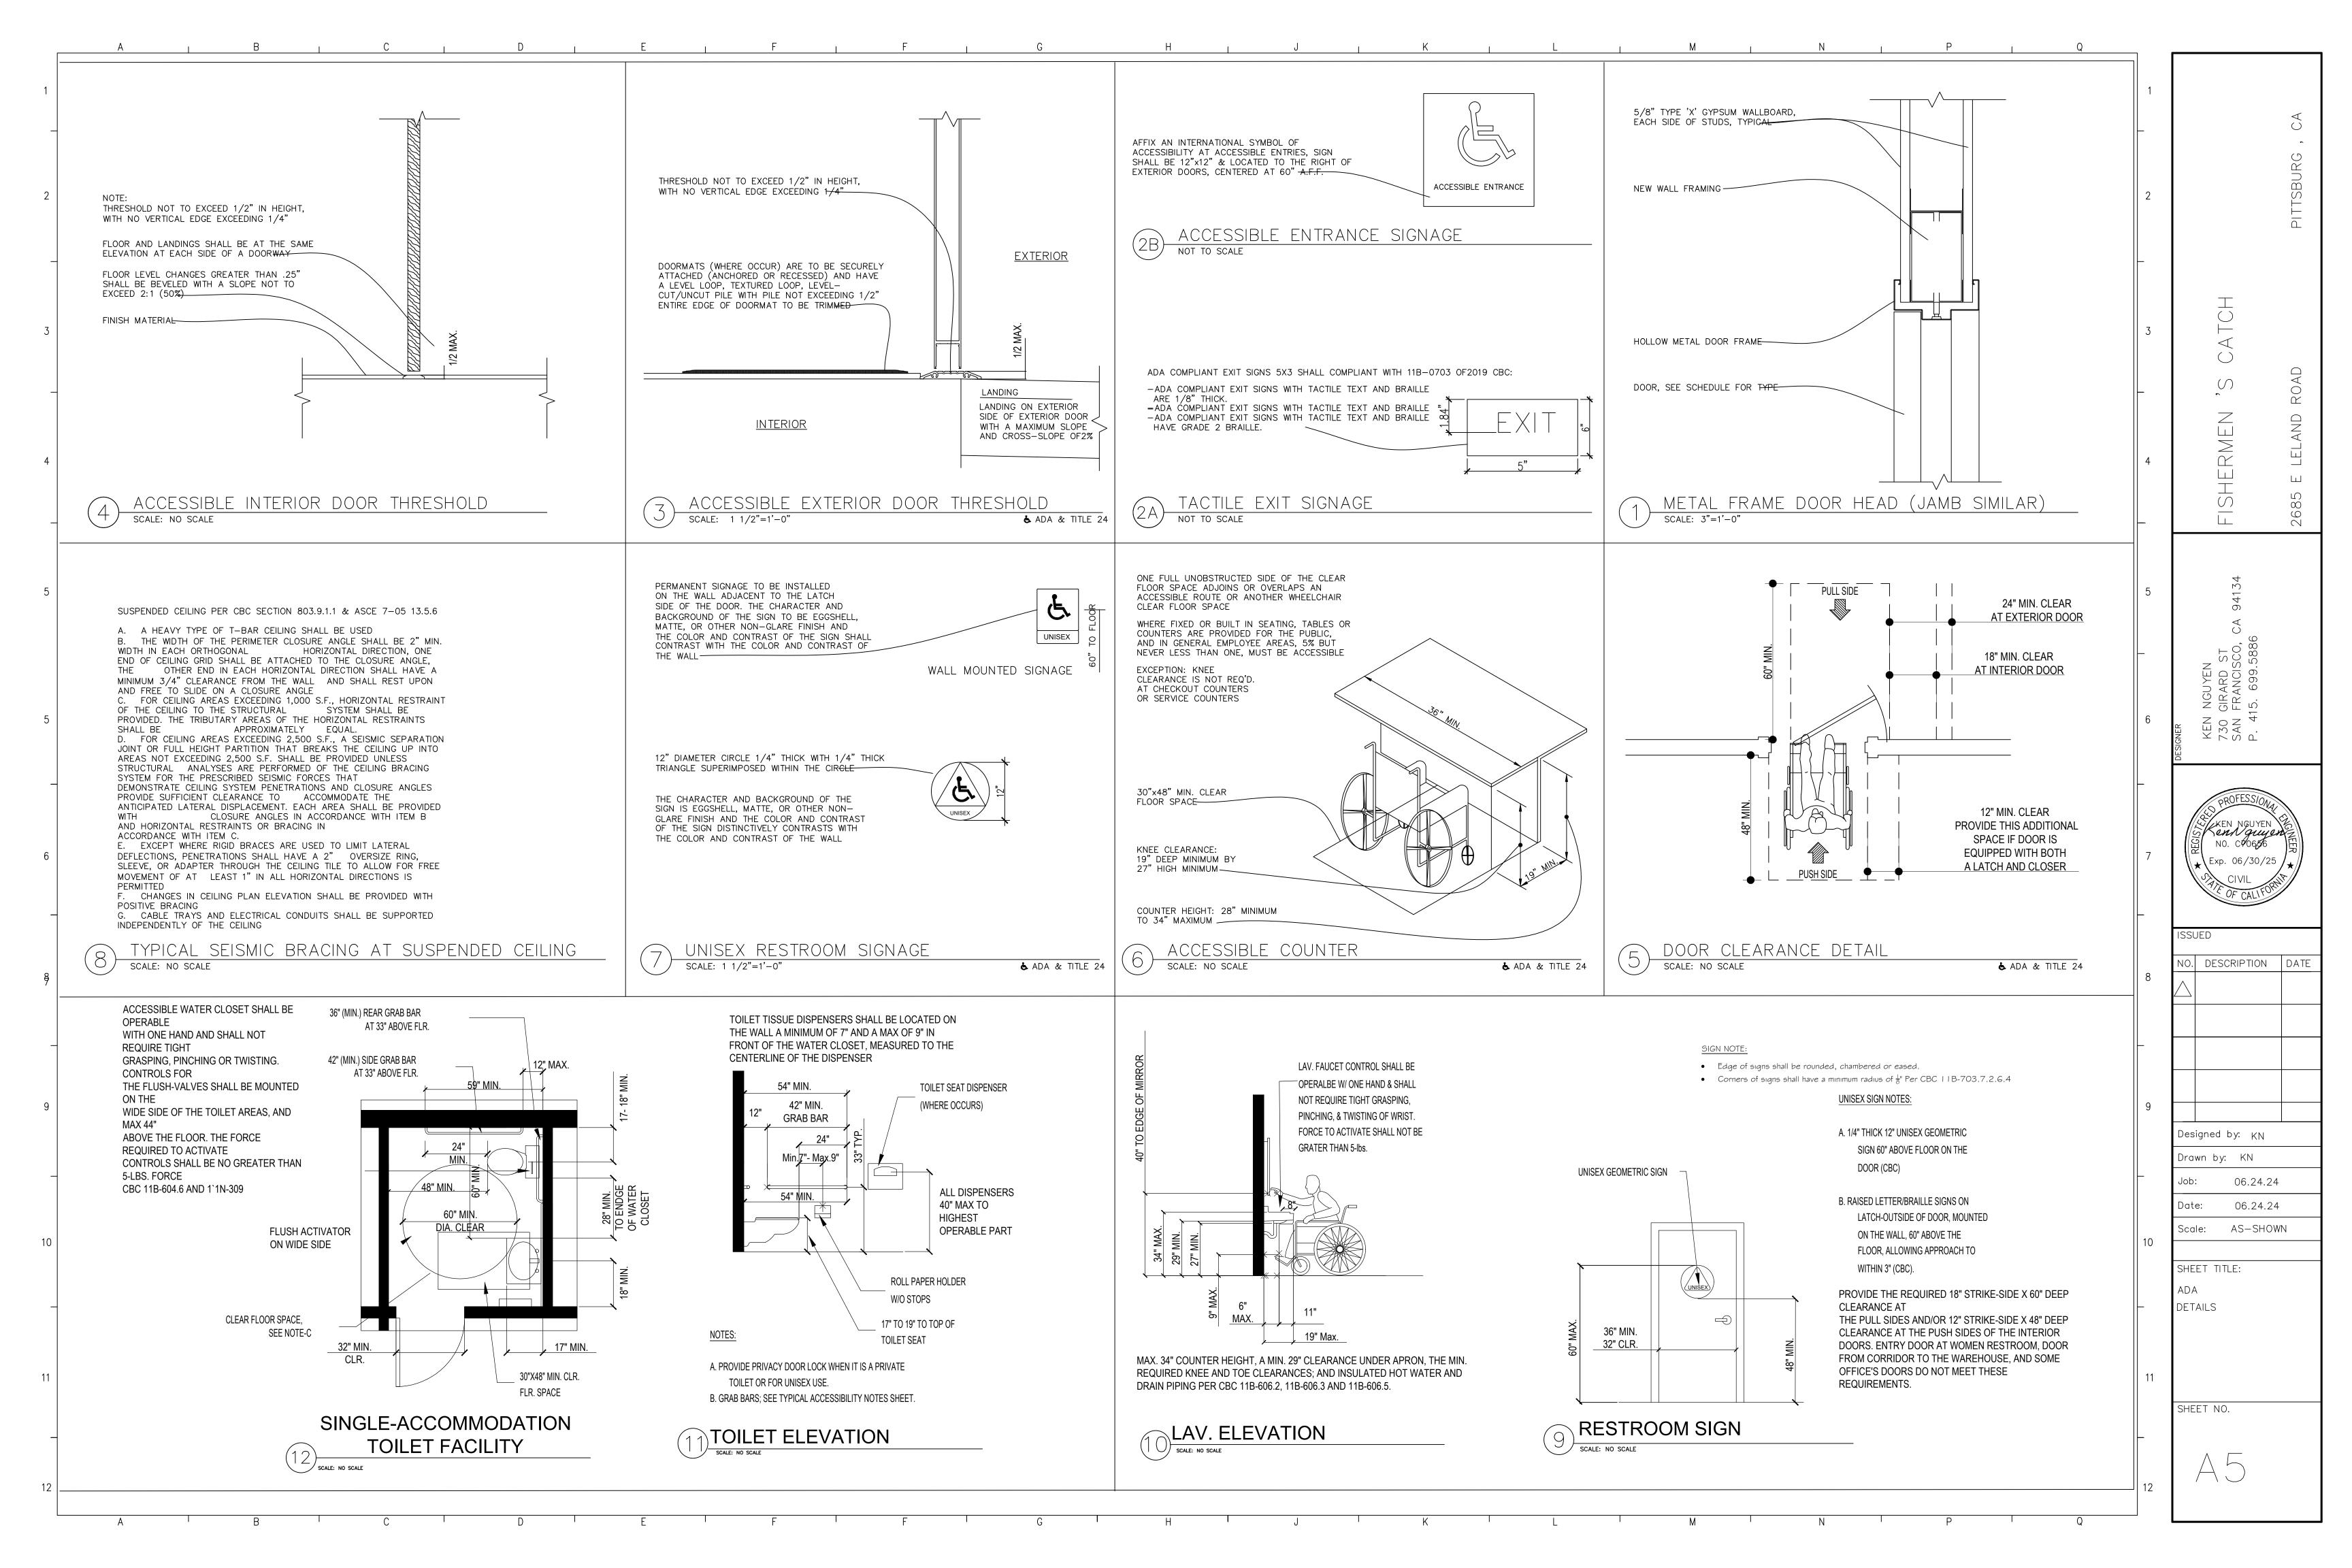

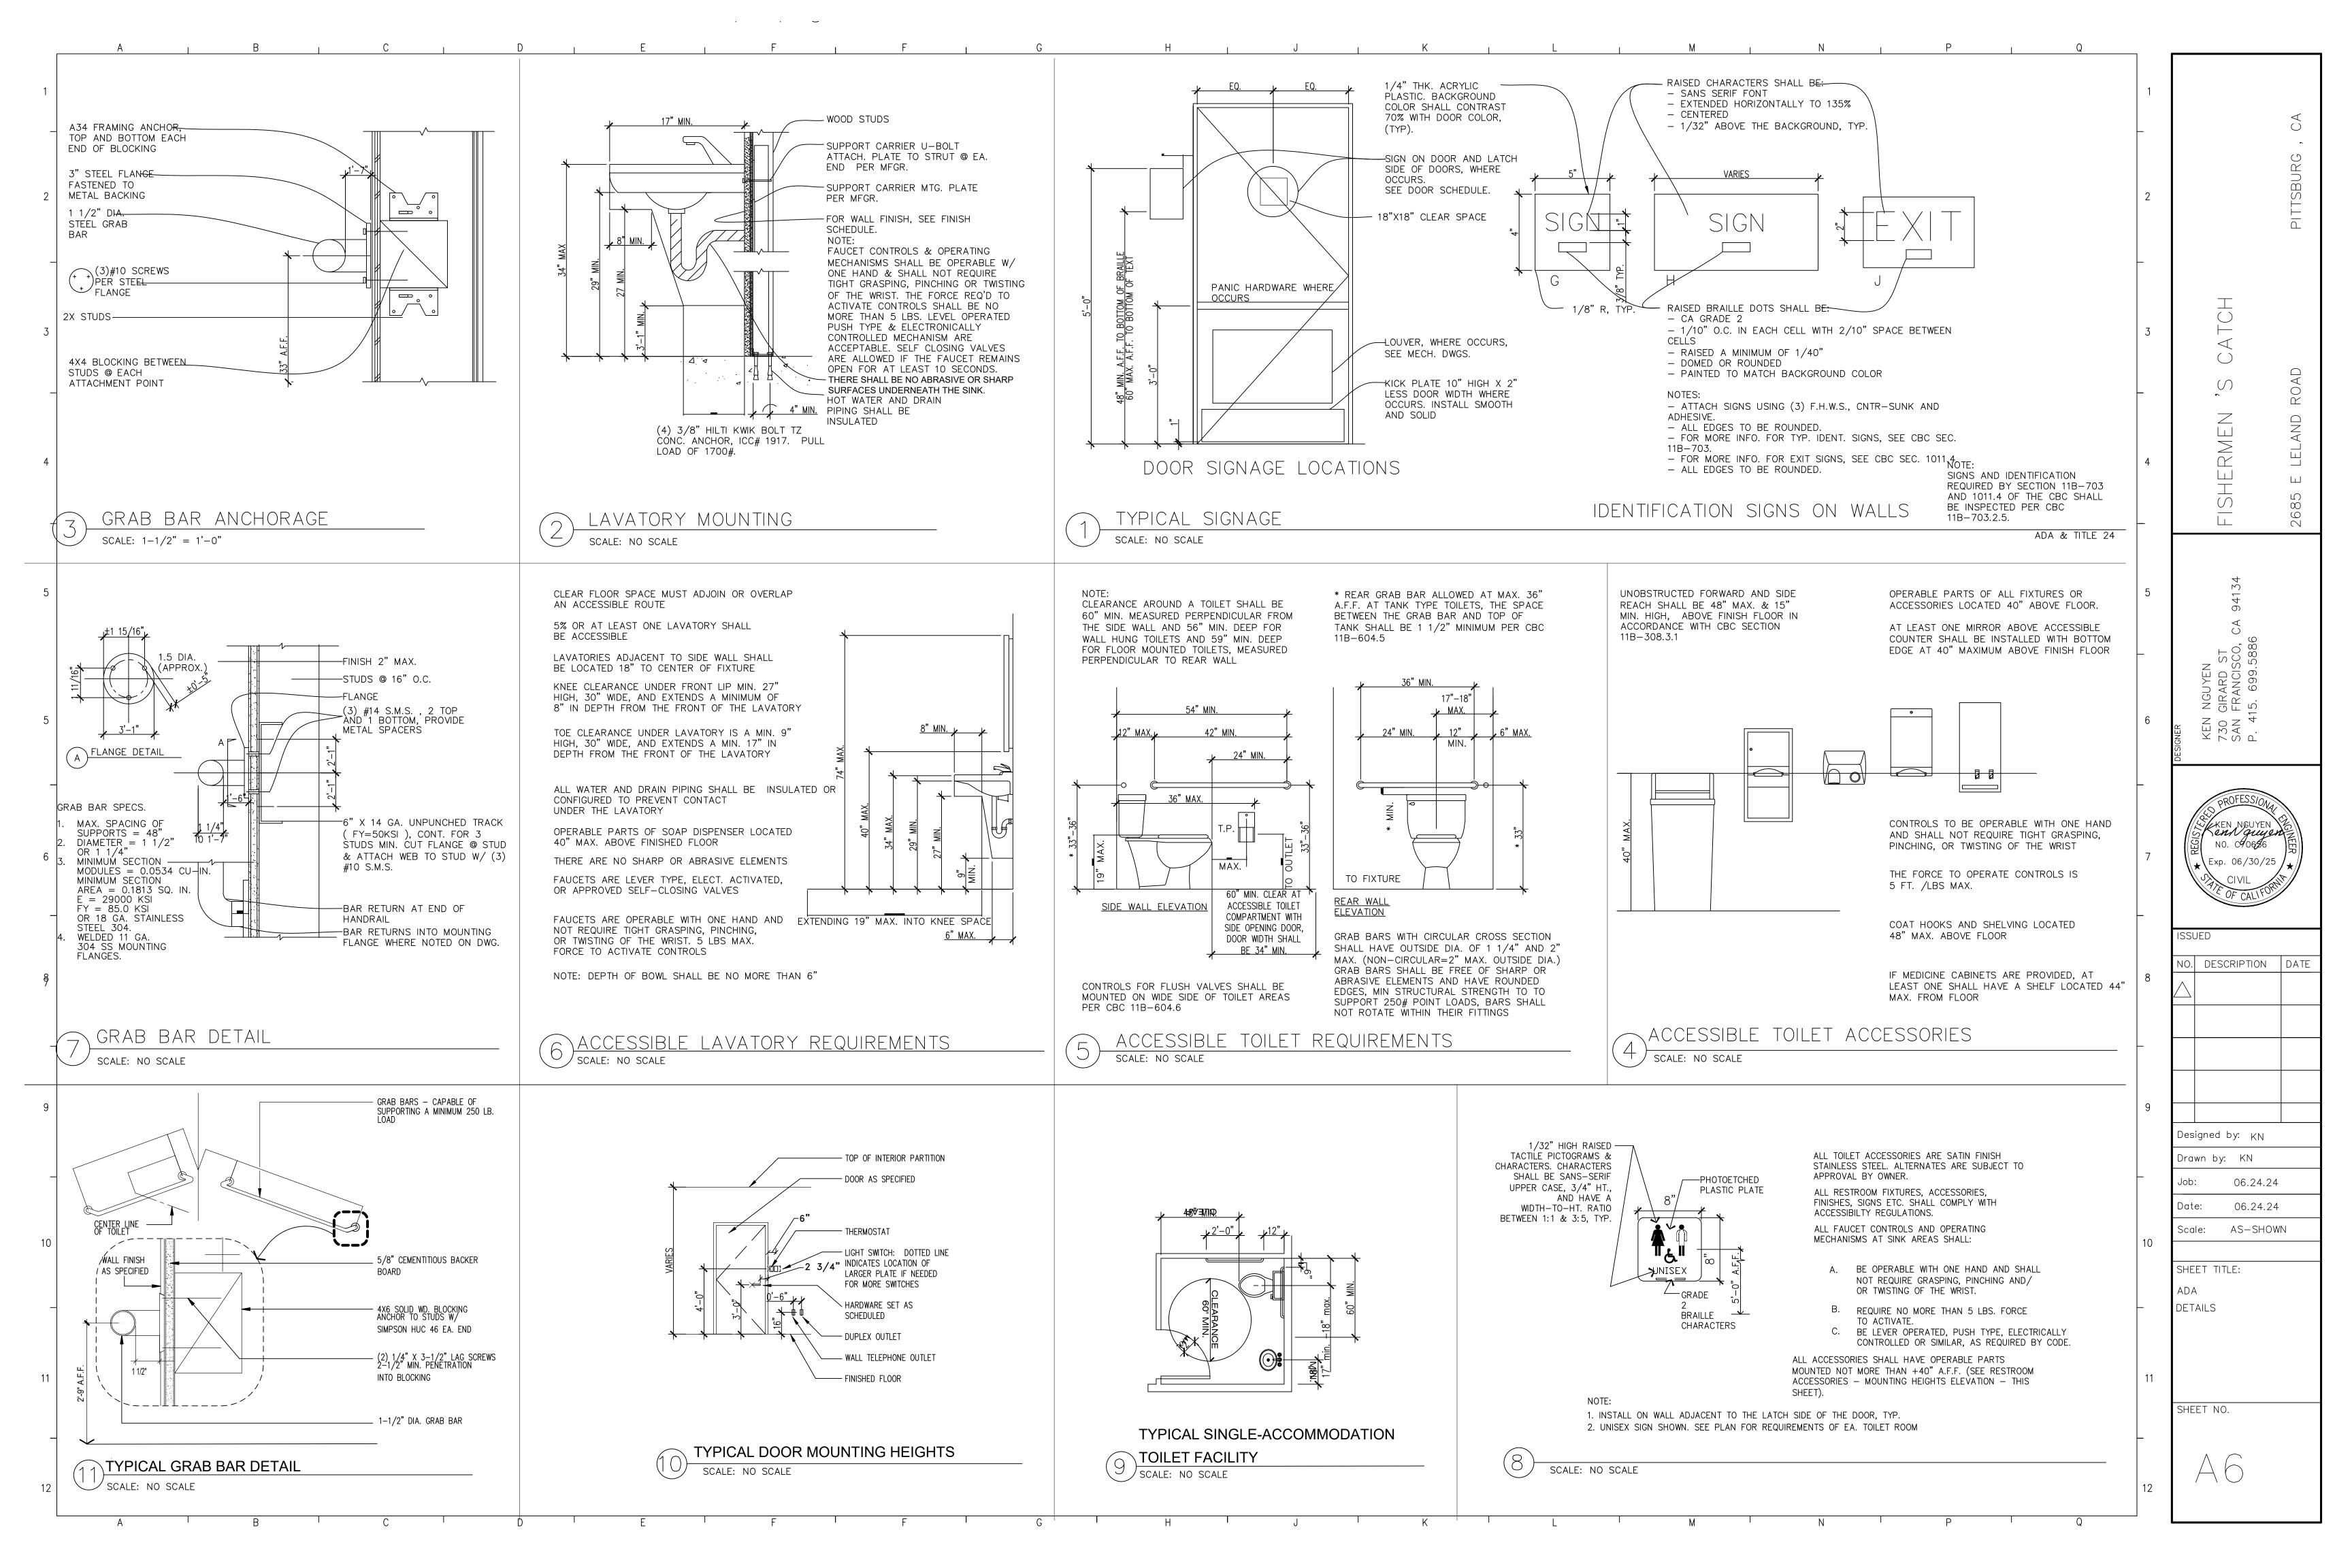

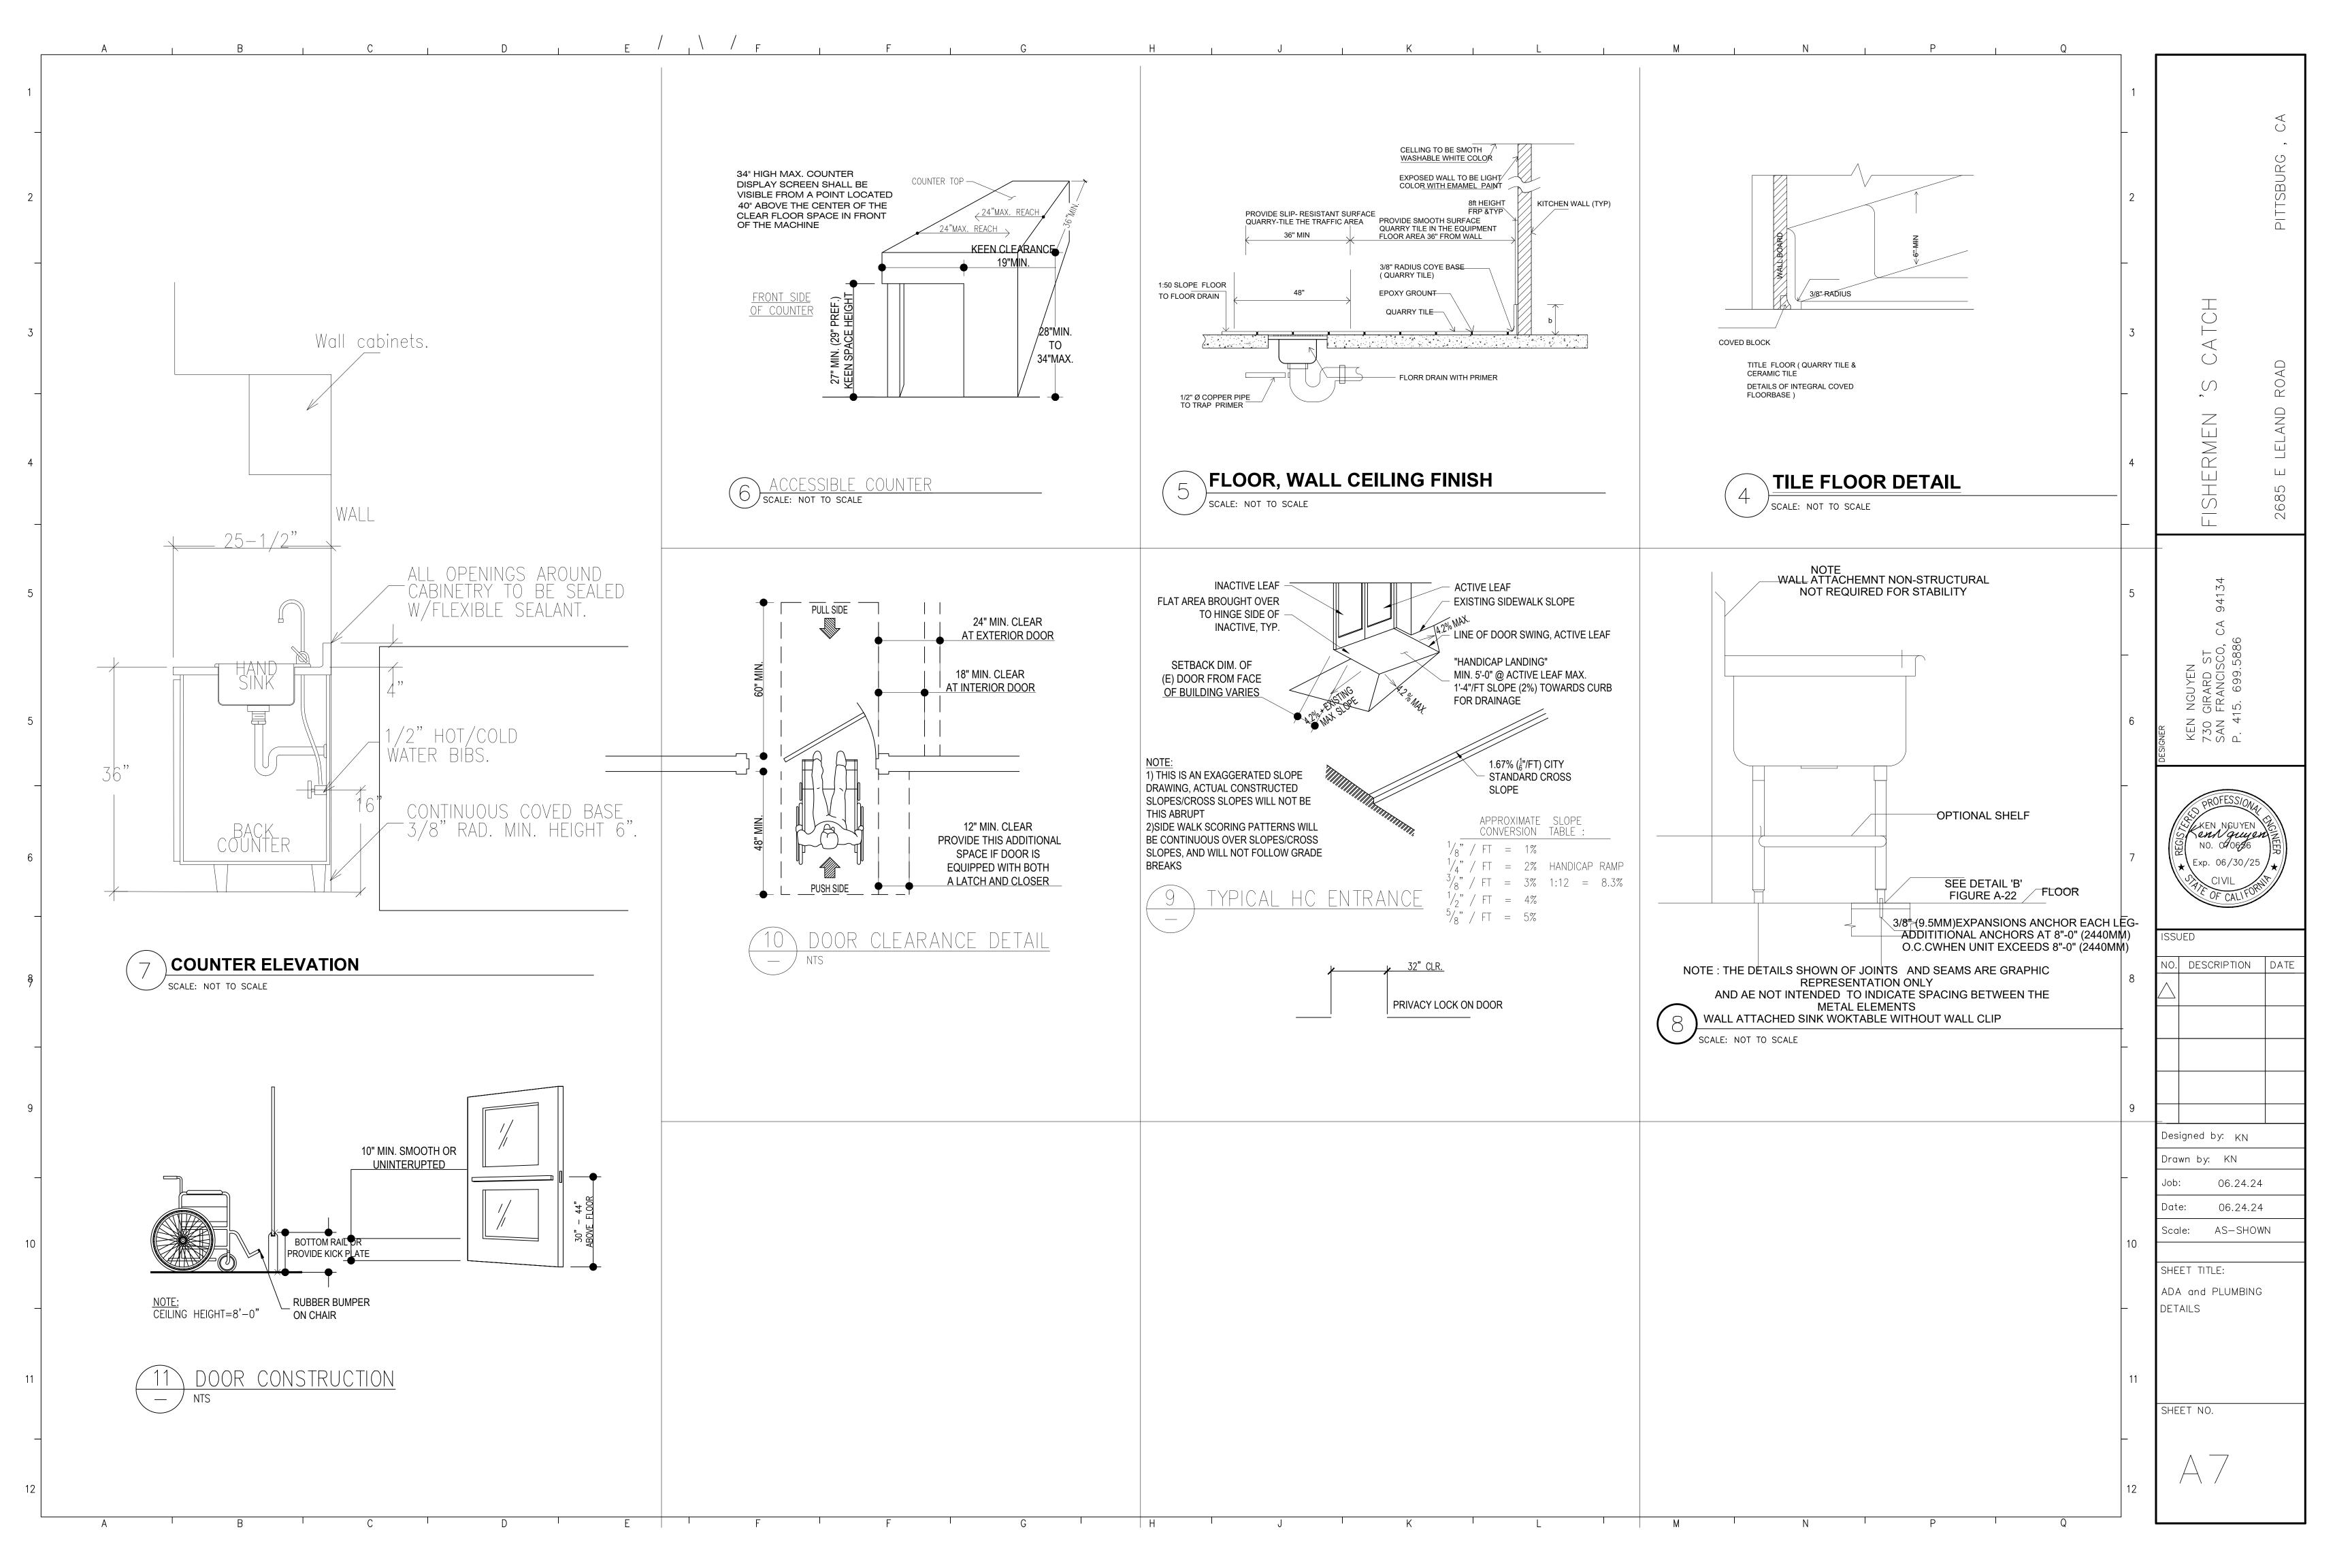

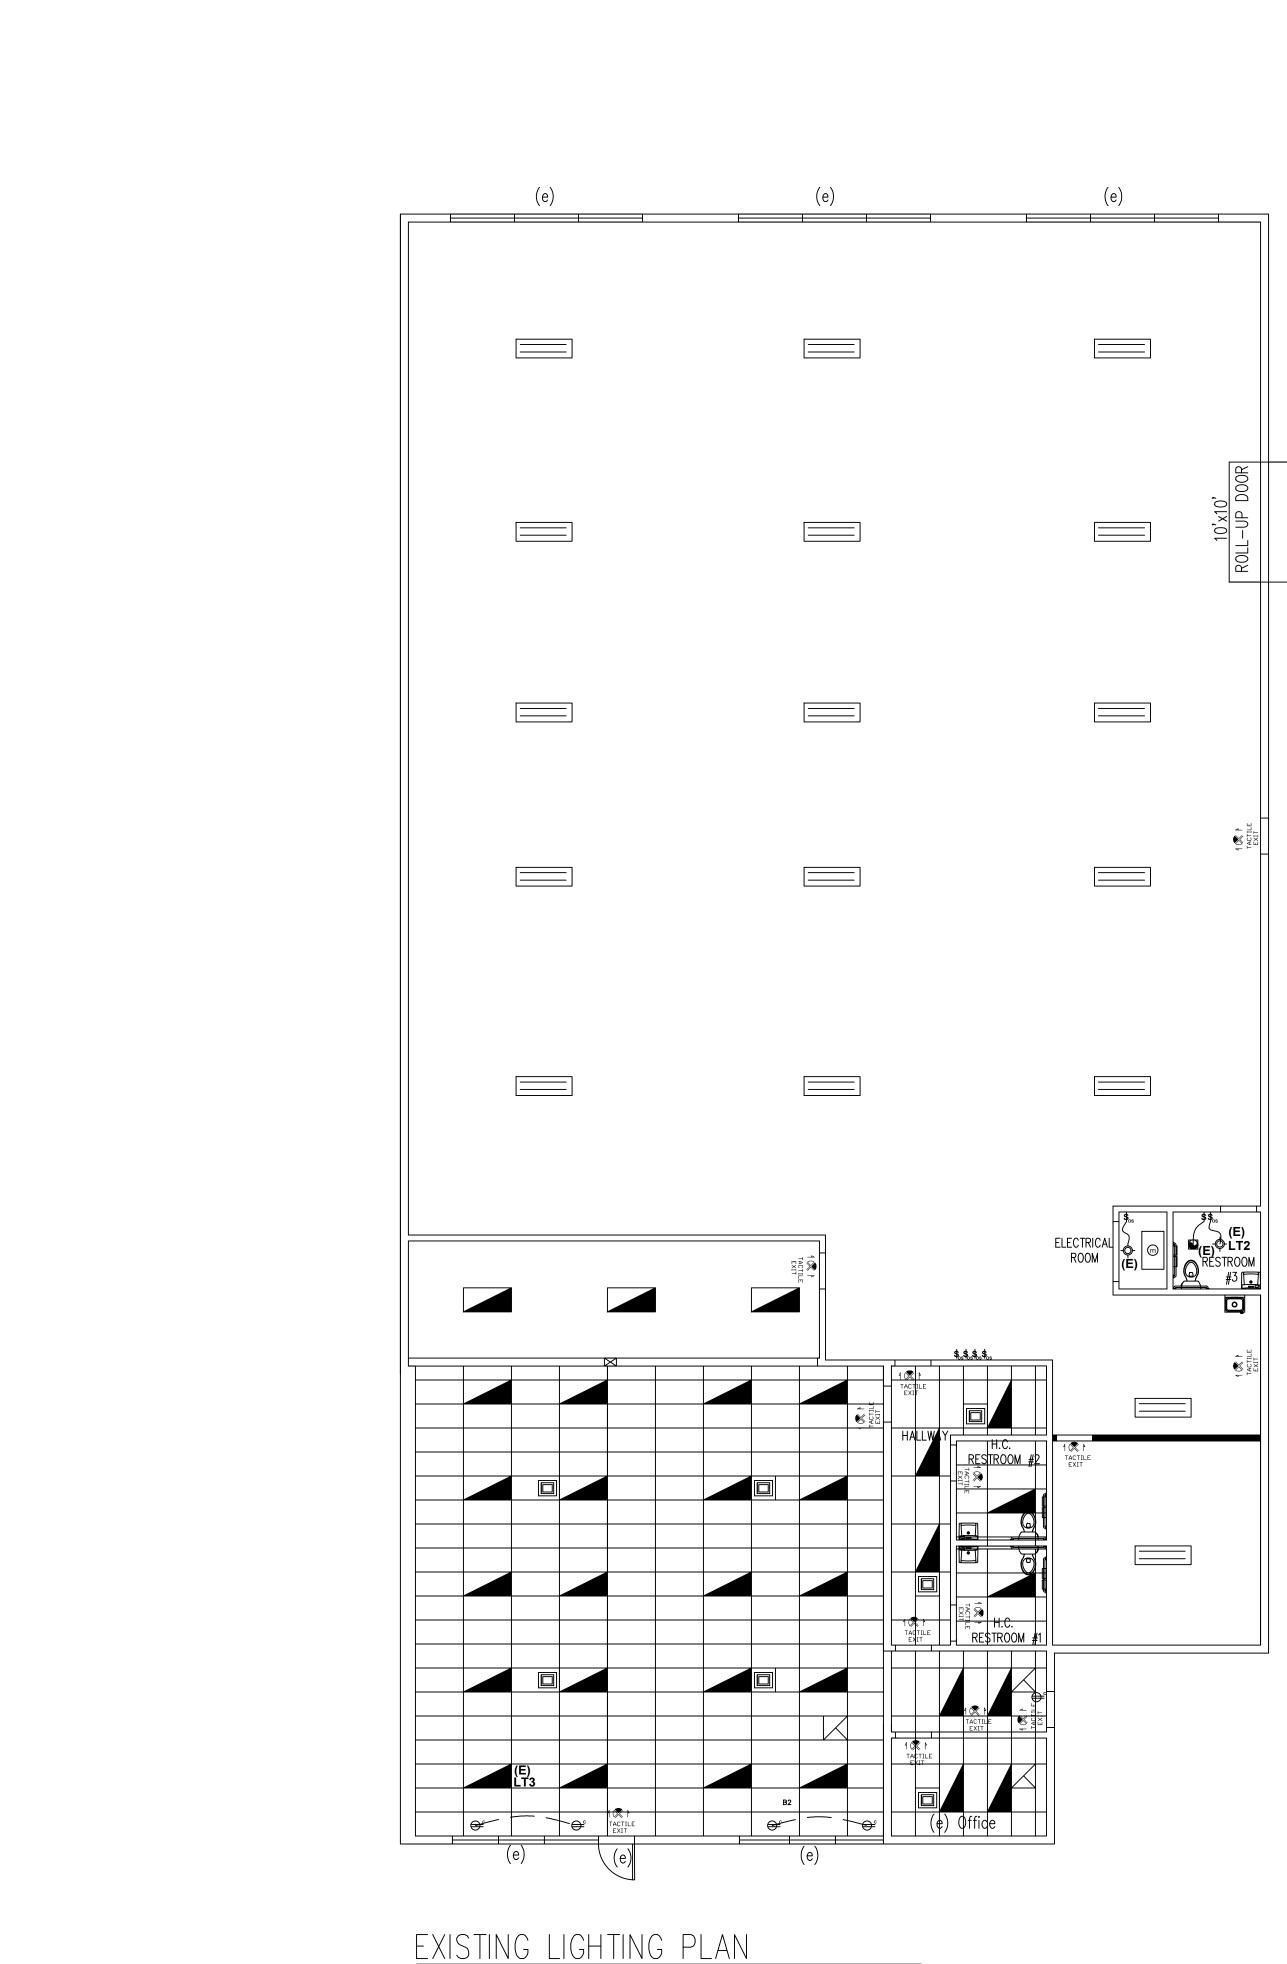


F

G

SCALE: ⅛" = 1'−0"

А

А

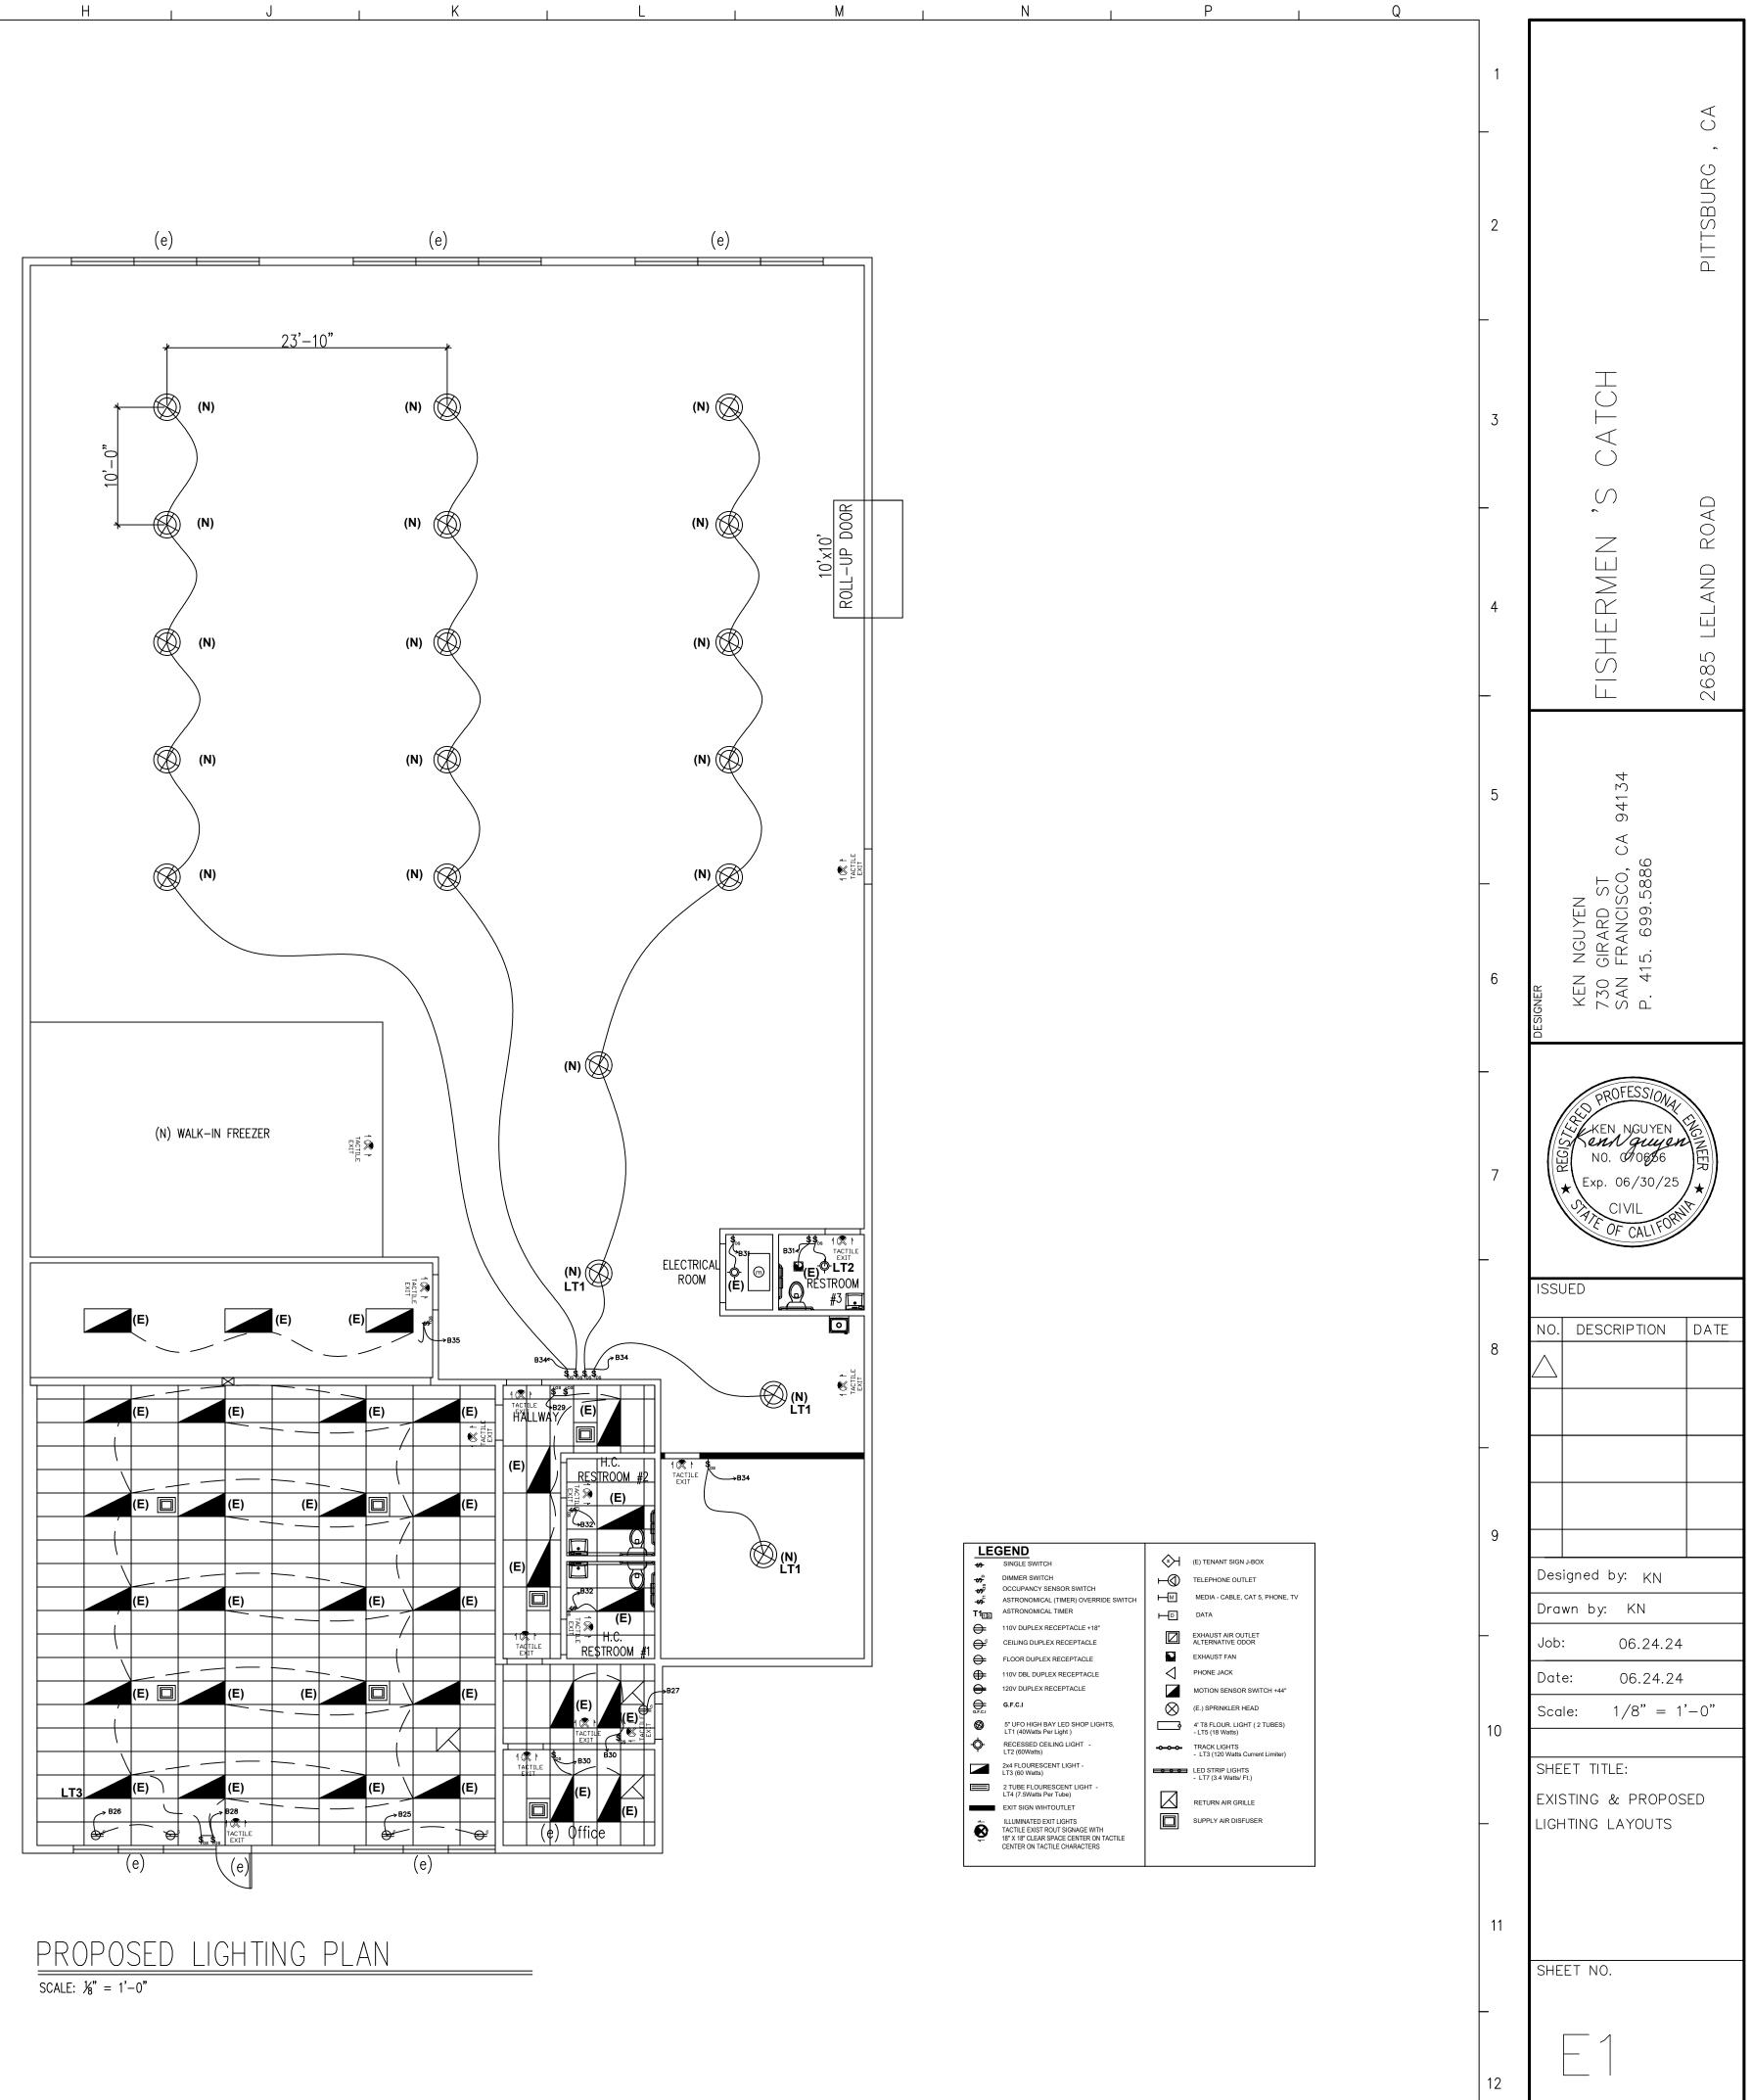


J

K


L

Н

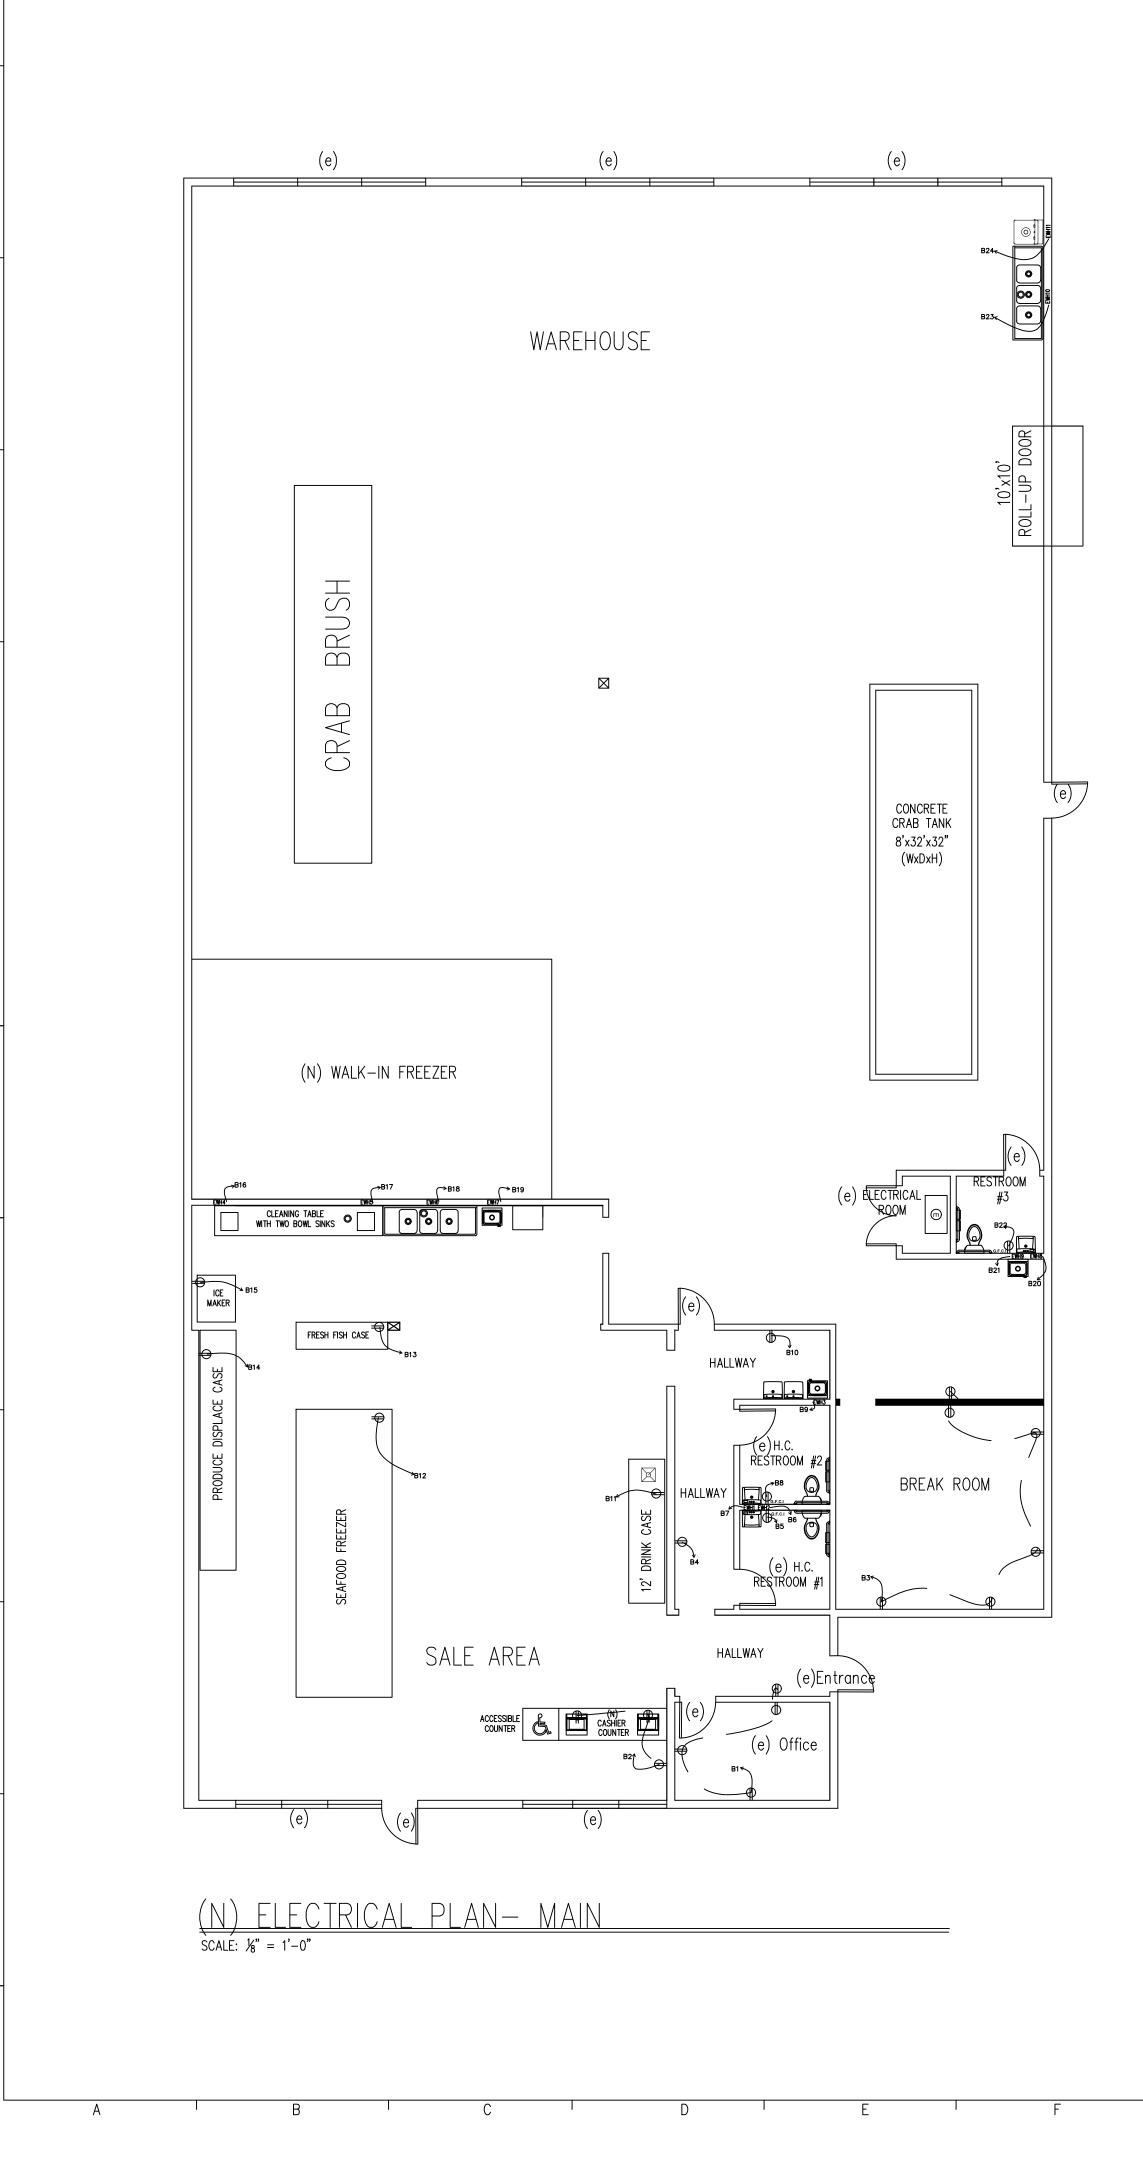

12

11

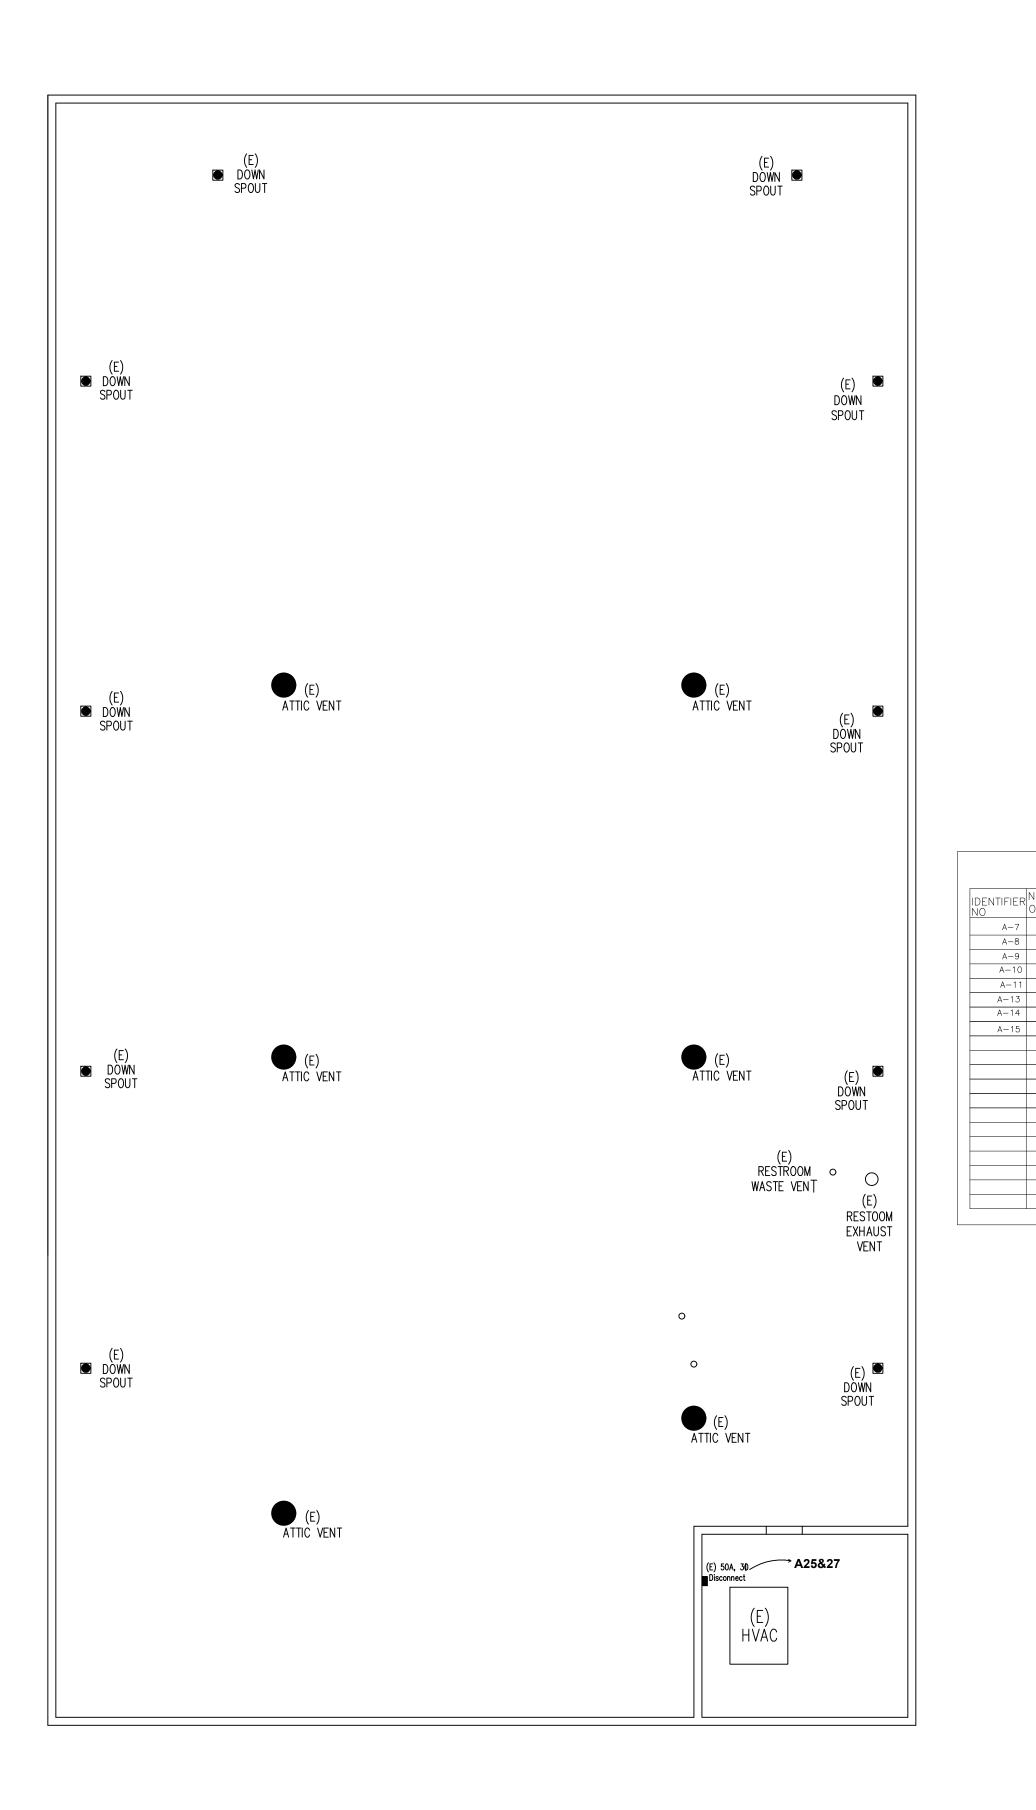

# (E) ELECTRICAL PLAN-ROOFscale: $\frac{1}{8}$ " = 1'-0"


Н

J

K

L


M		Ν	<u>ı                                    </u>	D	1	Q	_
							1
							2
							_
							3
							4
							_
							5
IIT DESCRIPTION	ELECTRIC	CAL EQUIPTMEN	T SCHEDULE model number		POWER		6
oduce Displace Case oshizaki Ice Machine esh Fish Case		44 3/8"x12'x68 1/4" 4'x3' 4'x12'x5'	Hussmann IC3SL_0125 F-2001MRH3 Hussmann DSF-12-REM OWEZV; Serial No. 116499		120V/60/10; 1.4 <b>2/</b> A; 10 120V/60/1Ø; 400W; 20 115V/60/1Ø; 16A 120V/60/1Ø; 0.440A		$\left  \right $
a Food Freezer ue Refrigeration — Drink Case Ilk—in Cooler (DEFERRED UNDER SEPAR/ ECTRICAL WATER HEATER	29 ATE PERMIT)	8'x24'x24" 5/8"x 78 1/8"x78 5/8"	GDM-69-HC-LD CUSTOM COOLER SR-20L/208-P		115V/60/1∅; 7.3A; 1/2 120V/60/1∅; 3A 208V/60/1∅; 4,160W, 20		
ISTING AC UNIT			RGH090HDCA0AAAA		208V/230V/60/1 <b>\$</b> ; 45A		7
							_
							-
							8
							8
							8
							_
							8
							_
							_
							_
							_
							9
							9
							9

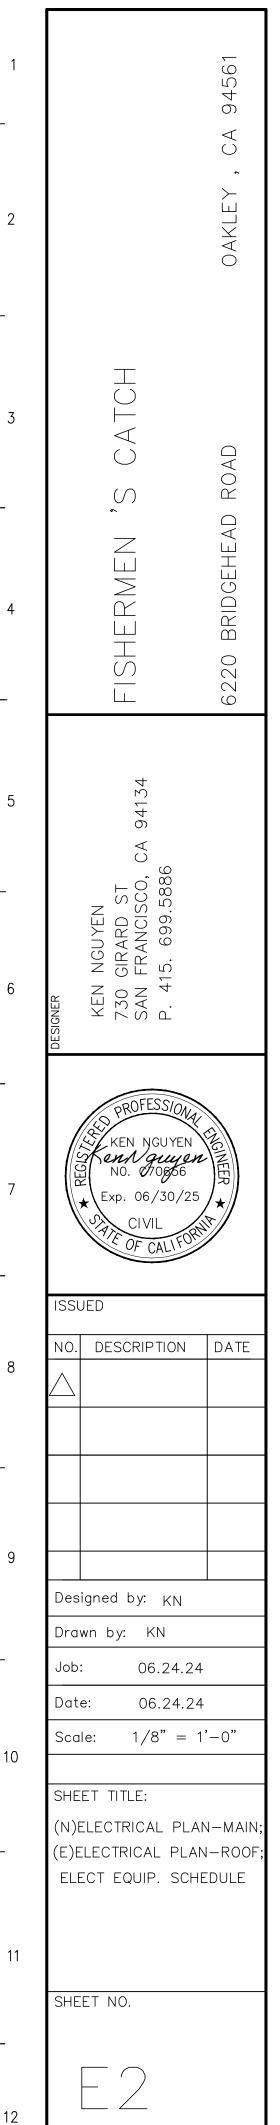

Ν

М



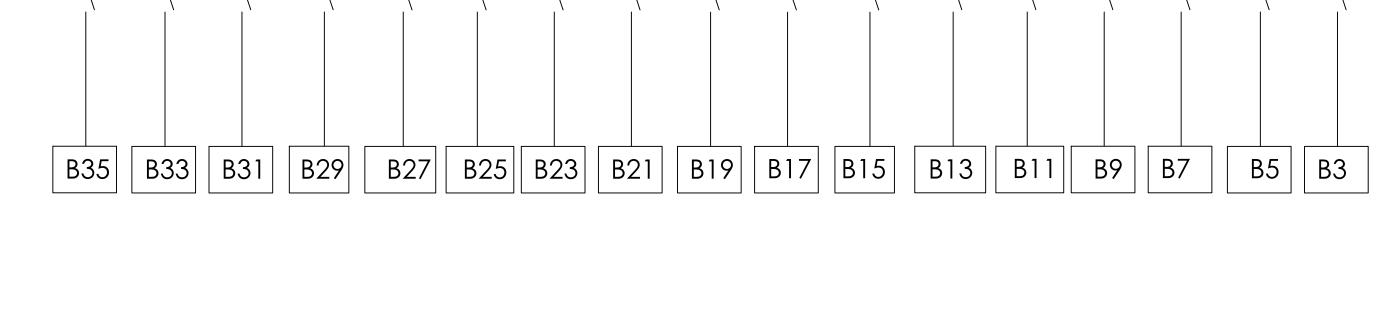


EXISTING N	AIN PA	NEL	A	ND	)	L(	C	AD (	CALCU	LATION
(E) PANEL : MAIN			VOLI	AGE	:	208	3Y/1	20	BUS : 40	A00
TYPE : MAIN PLUG		3 PH	IASE		WIF	E	4		AIC	MATCH EXISTING SERVICE PANE
DESCRIPTION	LOAD (KW)	С.В.	NO.		s/N	I	NO.	С.В.	LOAD (KW)	DESCRIPTION
AC UNIT	36.60	50/3	1	+	+	-	2	250/3	57.222	SUB PANEL A
AC UNIT		50/3	3	+	┢┤	-[	4	250/3		SUB PANEL A
AC UNIT		50/3	5	+	+	- [	6	250/3		SUB PANEL A
			7	+	+	-[	8			
			9	+	┢┥	- [	10			
			11	+	┼┥	- [	12			
			13	+	+	-[	14			
			15			-[	16			
			17	+		-	18			
TOTAL:	36.600 K	w							57.222 K	w
		100% C	ONNI	ECTE	DТ	DTA	LLC	DAD =	93.822 K	w
			-		тоти				93.222 K	

Α

10

12 |

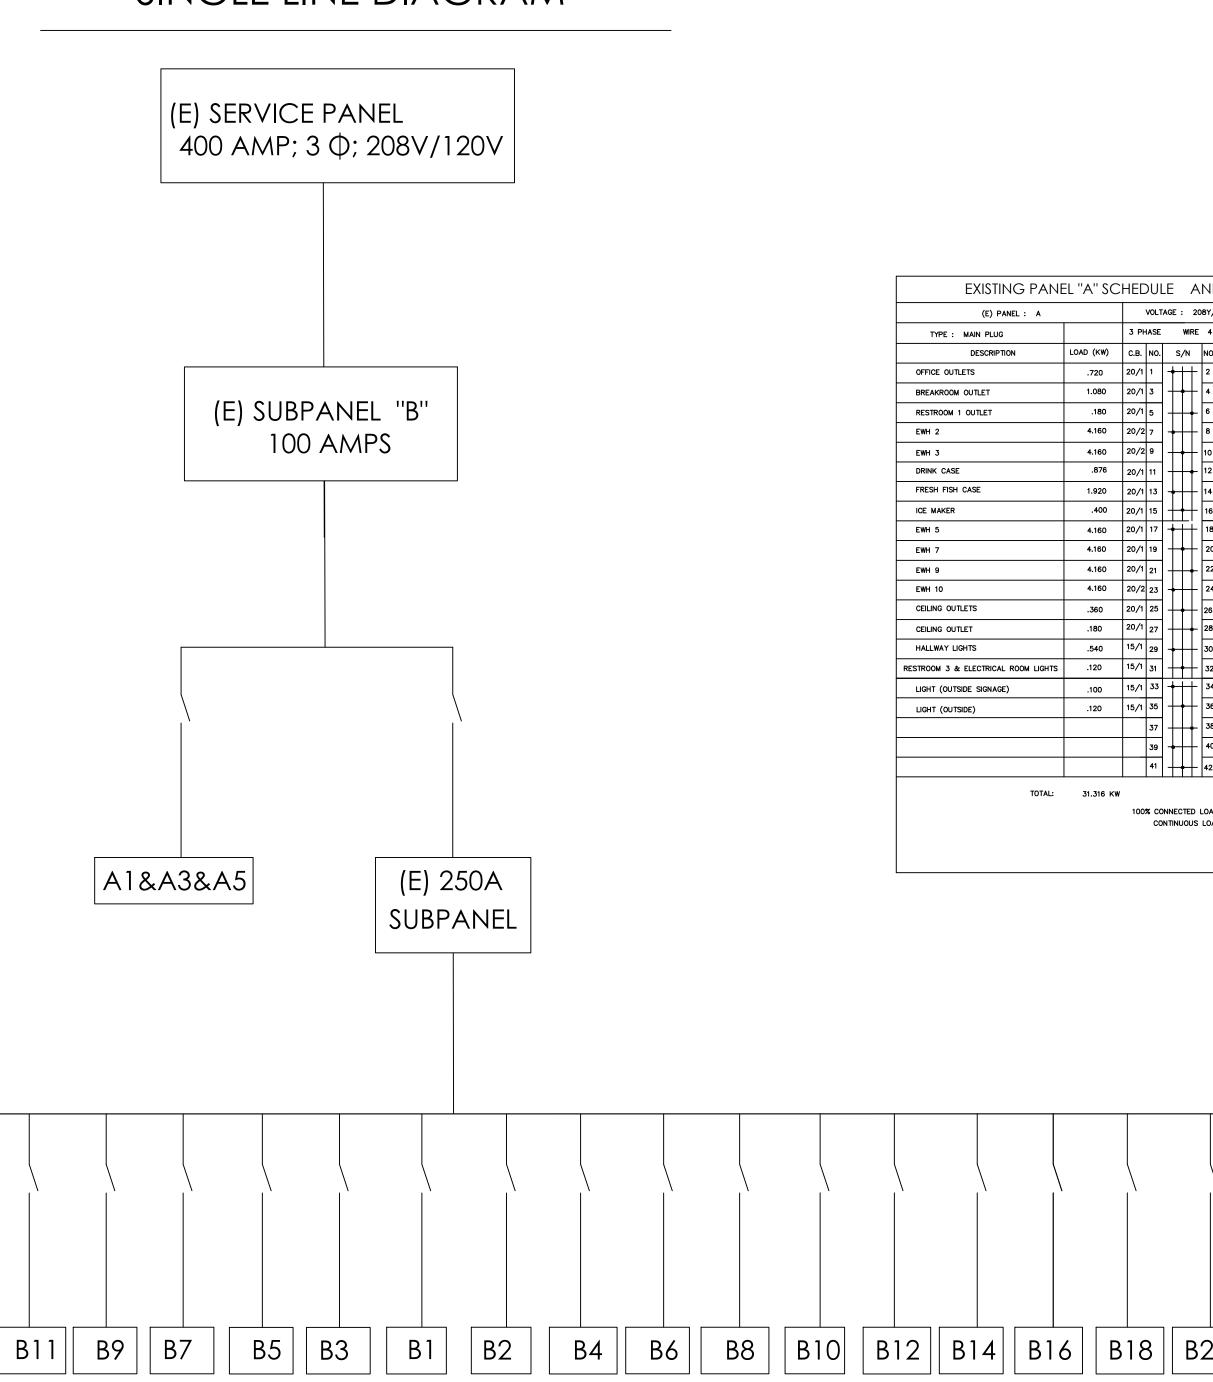


Н

J


G


## SINGLE LINE DIAGRAM


	1	CA 94561
	2	OAKLEY , C,
	3	RMEN'S CATCH
AND LOAD CALCULATION	4	FISHERMEN 'S C 6220 BRIDGEHEAD ROAD
208Y/120       BUS: $250A$ WRE $4$ AIC       MATCH EXISTING SERVICE PANEL         NN.       C.B.       LOAD (KW)       DESCRIPTION         2       15/1       .540       CASHIER OUTLETS         4       20/1       .180       HALLWAY OUTLET         6       20/1       .015       RESTROOM 2 OUTLET         10 $20/1$ .0528       SEAFOOD CASE	5	A 94134
14       20/1       .105       PRODUCE DISPLACE CASE         16       20/1       4.160       EWH 4         18       15/1       4.160       EWH 6         20       20/1       4.160       EWH 8         22       20/1       1.180       RESTROOM 3 OUTLET         24       20/1       4.160       EWH 11         26       20/1       1.360       CEILING OUTLETS         28       20/1       1.200       LIGHTS AT SALE AREA         30       15/1       .240       OFFICE LIGHTS	6	DESIGNER KEN NGUYEN 730 GIRARD ST SAN FRANCISCO, C P. 415. 699.5886 P. 415. 699.5886
32       15/1       .120       RESTROOM 1&2 LIGHTS         34       15/1       .760       BREAKROOM AND WAREHOUSE LIGHTS         36       38       38         40       40       40         42       40       40         152.089 KW       1005 LOAD       TOTAL KVA       = 56.405 KVA         1005 LOAD       3.354 KVA $0257$ = .839 KVA         1005 LOAD       57.244KVA       KVA/ .360       = 159.011 AMPS	7	KEN NGUYEN KEN NGUYEN NO. C70656 Exp. 06/30/25 ↓ CIVIL FOF CALLFORM
	8	ISSUED NO. DESCRIPTION DATE
	9	Designed by: KN
B20 B22 B24 B26 B28 B30 B32 B34	10	Drawn by: KN Job: 06.24.24 Date: 06.24.24 Scale: NTS SHEET TITLE:
	11	PANEL &LOAD SCHEDULES; SINGLE LINE DIAGRAM.
	12	SHEET NO.

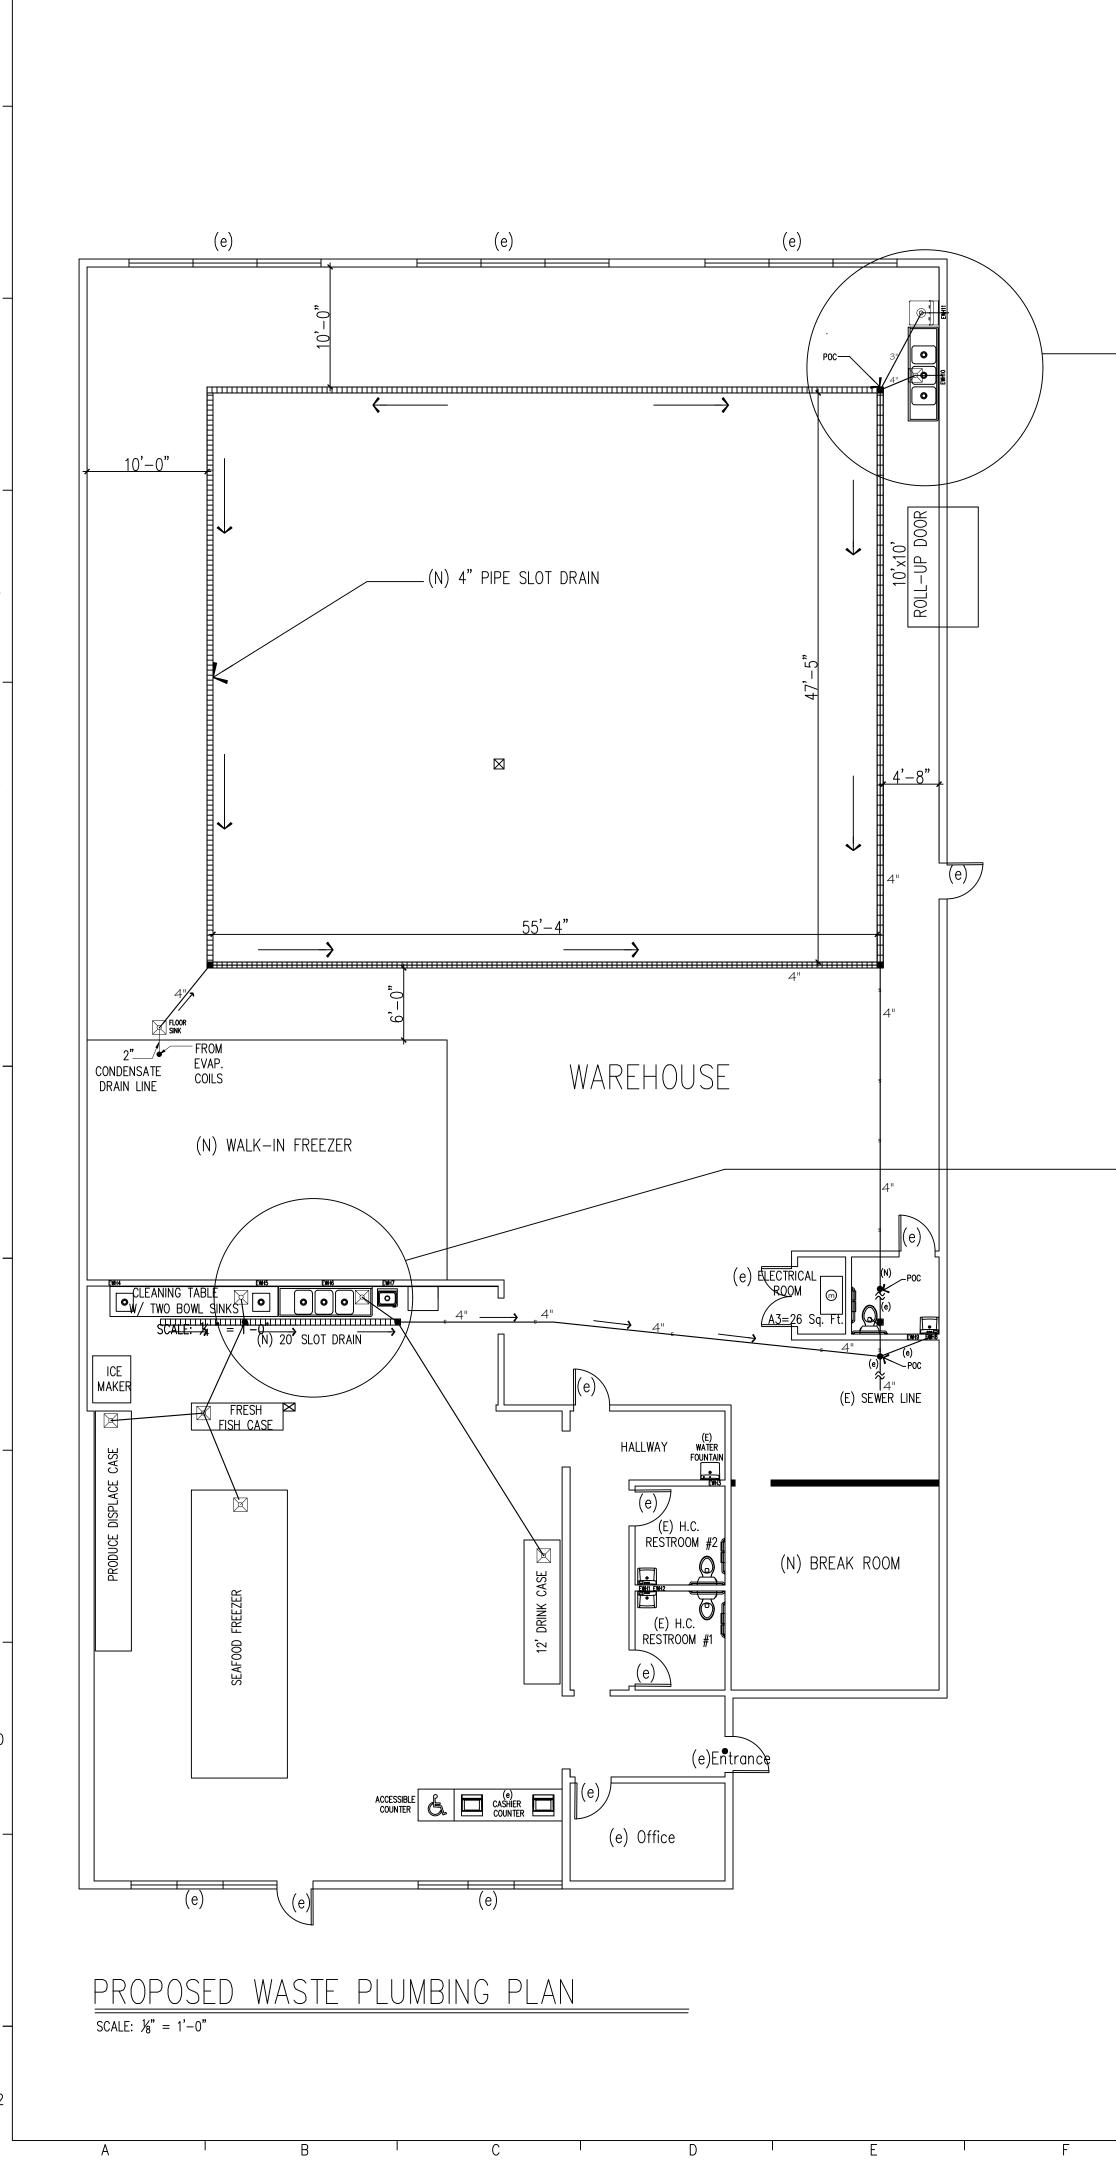

F

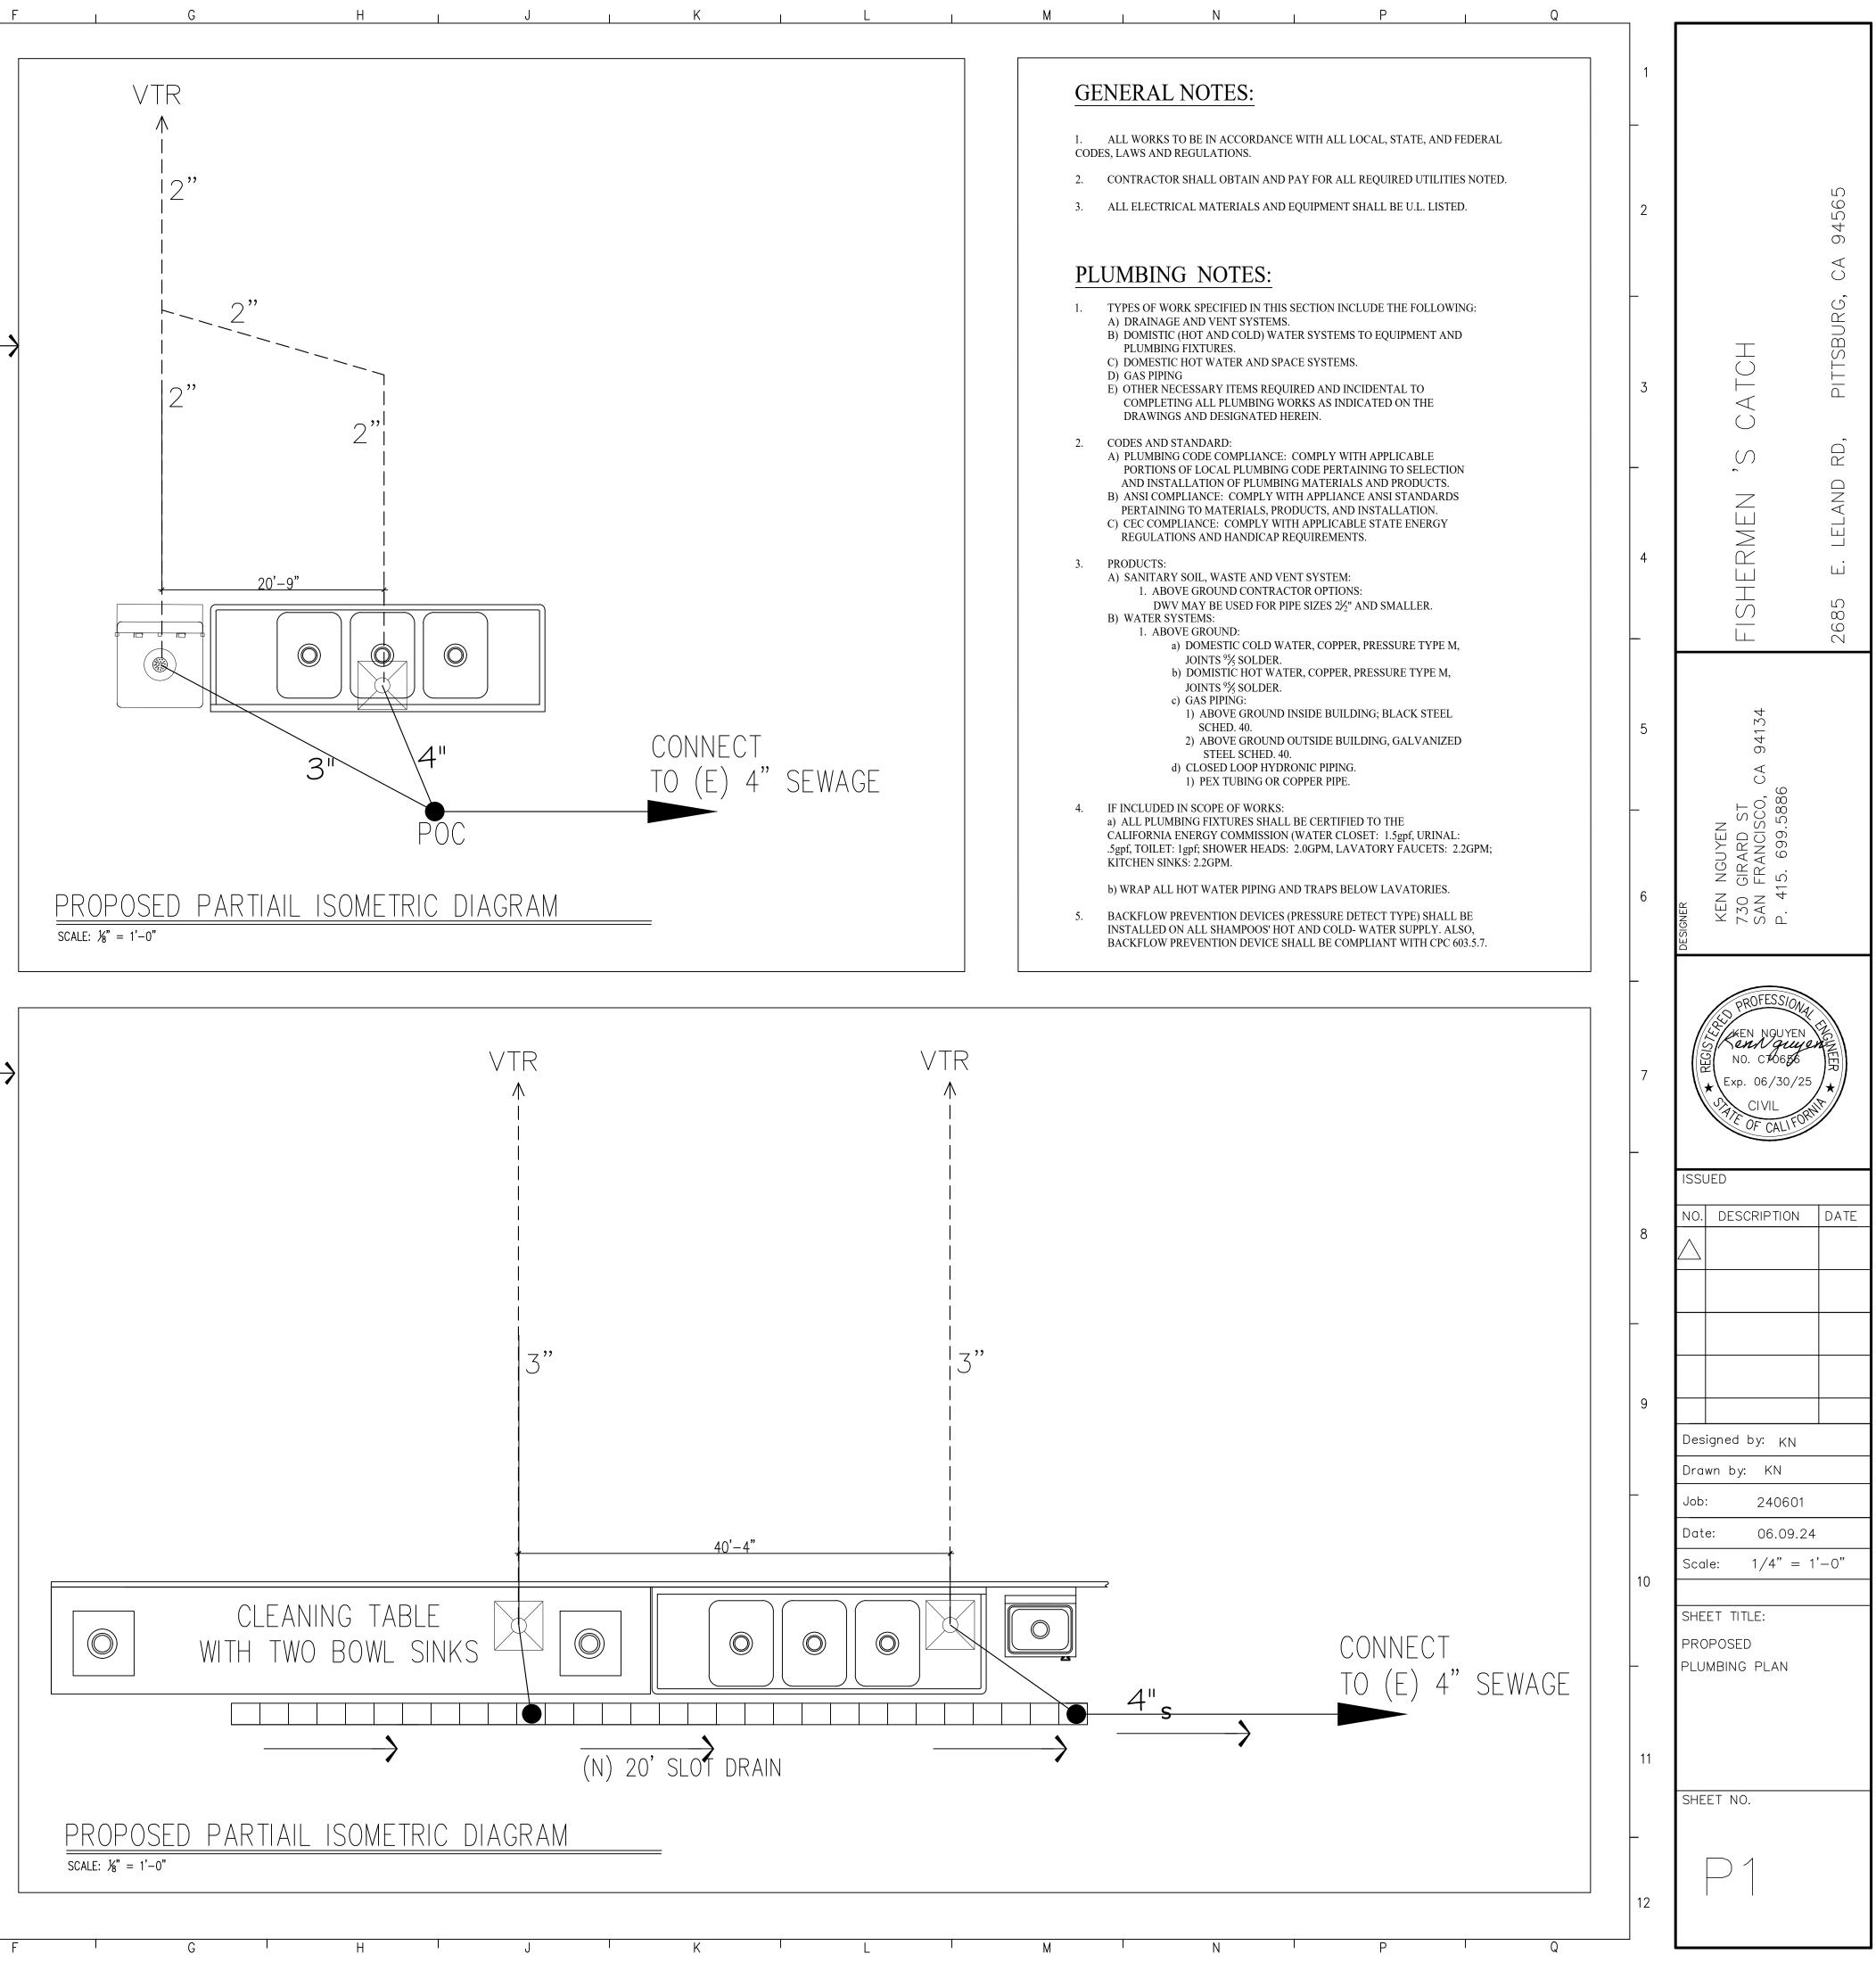

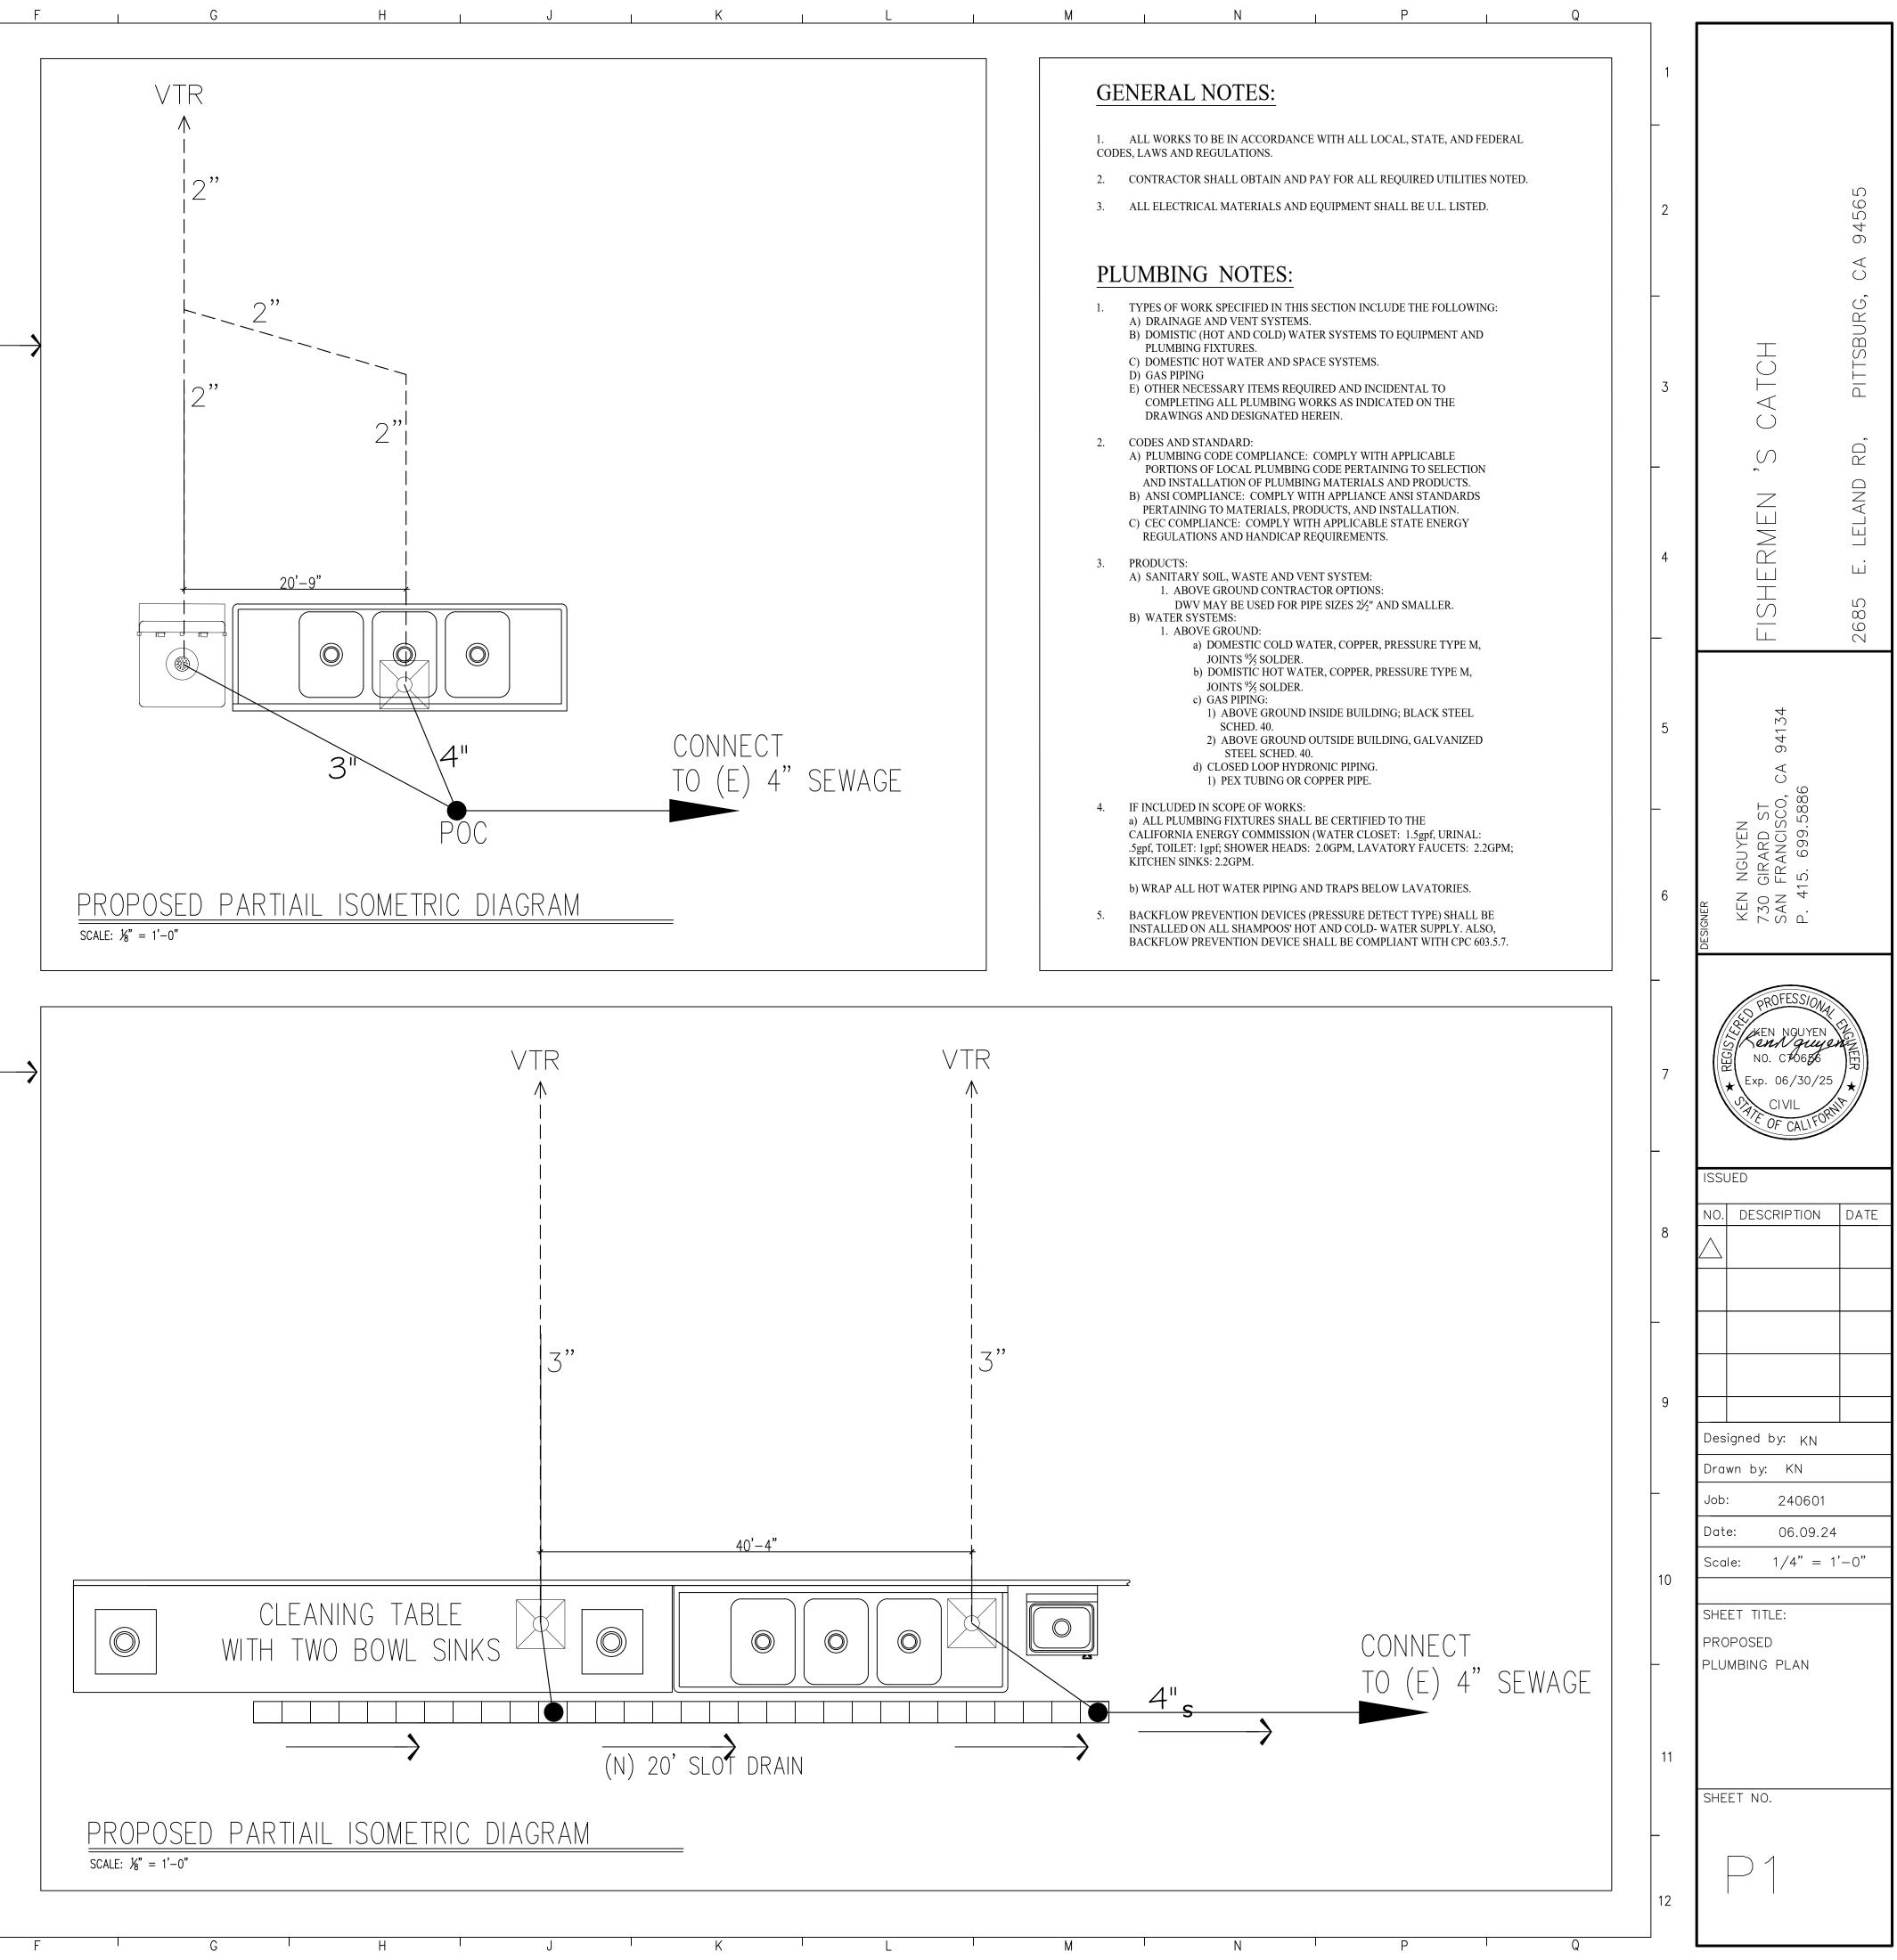

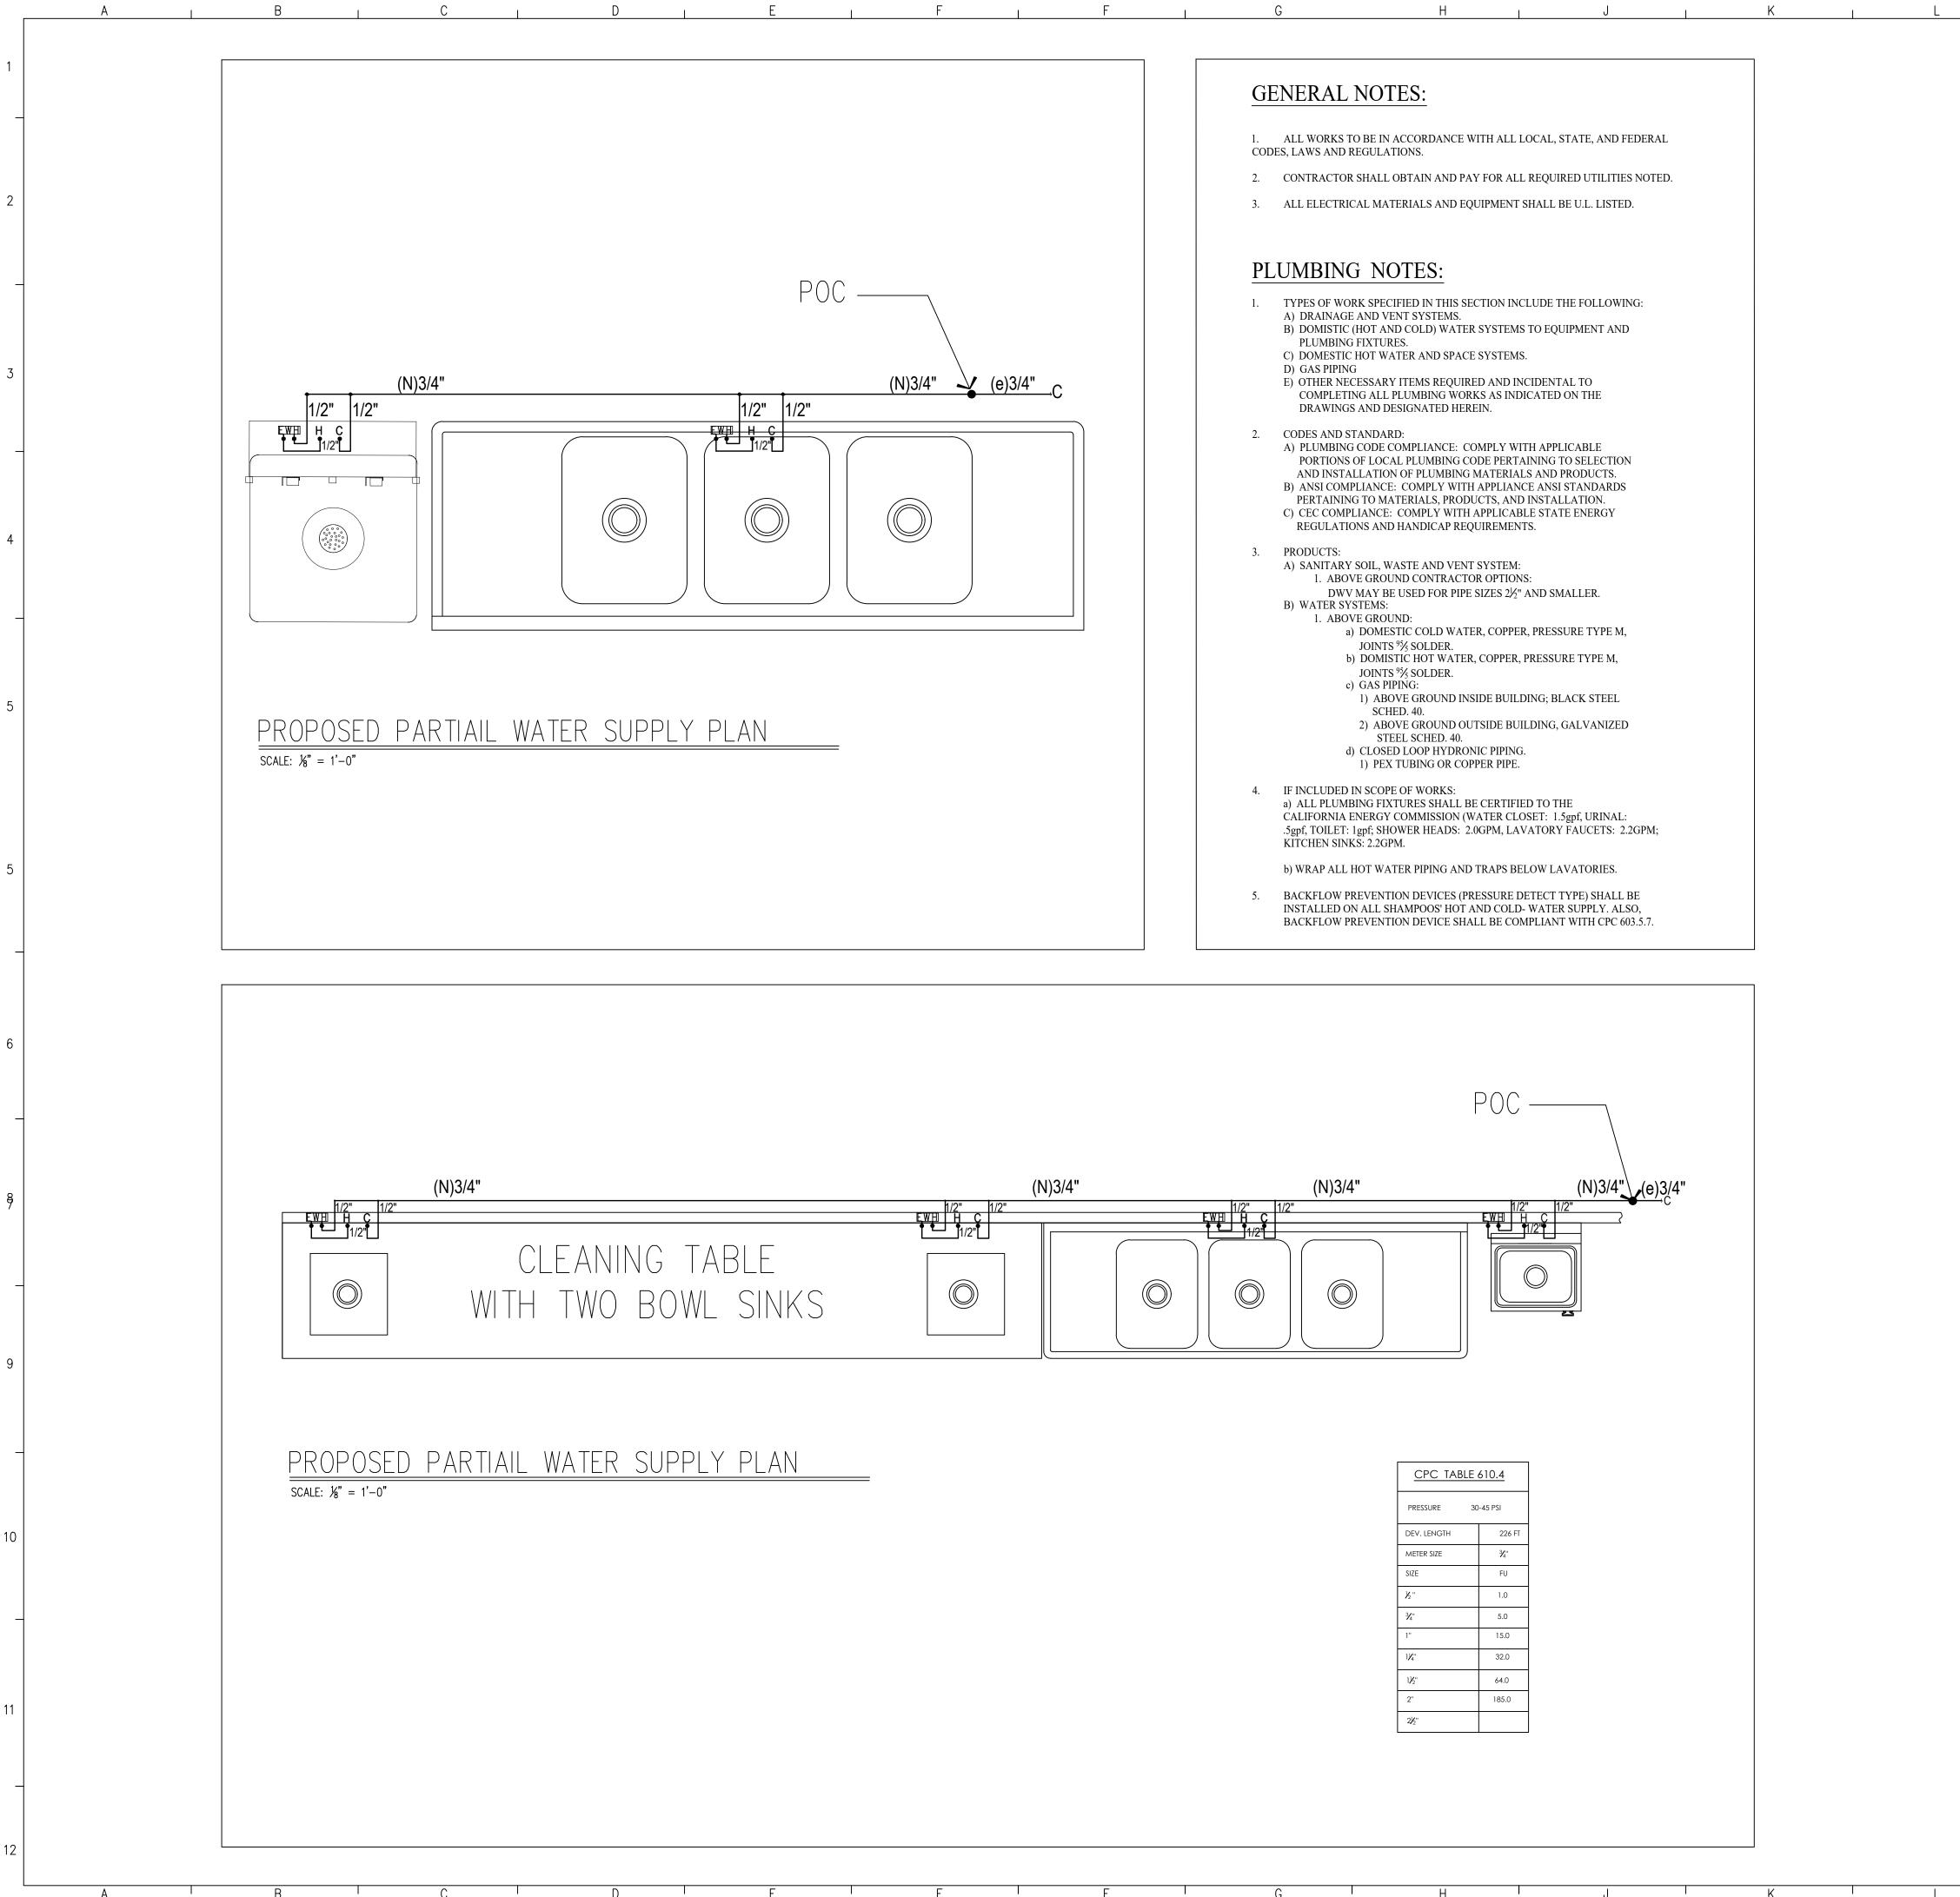







_		
1		
2	TCH Pittsburg, ca 94565	
3	EN'S CATCH d Rd. Pittsburg.	
4	FISHERMEN 2685 Leland Rd.	
5	, CA 94134	
6	DESIGNER KEN NGUYEN 730 GIRARD ST SAN FRANCISCO, CA 94134 P. 415. 699.5886 P. 415. 699.5886	
7	NO. C70686 Exp. 06/30/25 CIVIL FOF CALLFORNIN	
8	ISSUED NO. DESCRIPTION DAT	TE
9	Designed by: KN	
- 10	Drawn by: KN Job: 240601 Date: 06.09.24 Scale: 1/4" = 1'-0" SHEET TITLE: PROPOSED PLUMBING PLAN	
11	SHEET NO.	
12	Ρ2	

I N I P

Q

М

1

## NAILING SCHEDULE

NOTE: USE COMMON NAILS UNLESS OTHERWISE NOTED.


CONNECTION
JOIST TO SILL OR GIRDER, TOE NAIL
BRIDGING TO JOIST, TOE NAIL EACH END
1" x 6" SUBFLOOR OR LESS TO EACH JOIST, FACE NAIL
WIDER THAN 1" x 6" SUBFLOOR TO EACH JOIST, FACE NAIL
2" SUBFLOOR TO JOIST OR GIRDER, BLIND FACE AND NAIL
SOLE PLATE TO JOIST OR BLOCKING, FACE NAIL
TOP PLATE TO STUD, END NAIL
STUD TO SOLE PLATE, TOE NAIL
DOUBLE STUDS, FACE NAIL
DOUBLED TOP PLATES, FACE NAIL
TOP PLATES, LAPS AND INTERSECTIONS, FACE NAIL
CONTINUOUS HEADER, TWO PIECES
CEILING JOISTS TO PLATE, TOE NAIL
CONTINUOUS HEADER TO STUD, TOE NAIL
CEILING JOISTS, LAPS OVER PARTITIONS, FACE NAIL
CEILING JOISTS TO PARALLEL RAFTERS, FACE NAIL

RAFTER TO PLATE, TOE NAIL 1" BRACE TO EACH STUD AND PLATE, FACE NAIL 1" x 8" SHEATHING OR LESS TO EACH BEARING, FACE NAIL WIDER THAN 1" x 8" SHEATHING TO EACH BEARING, FACE NAIL BUILT-UP CORNER STUDS

NAILING
3-6d
2-8d
2-8d
3-8d
2–16d
16d AT 16" O.C.
2–16d
4-8d
16d AT 24" O.C.
16d AT 16" O.C.
2–16d
16d AT 16"O.C. ALONG EACH PIECE
3-8d
4-8d
3–16d
3–16d
3-8d
2-8d
2-8d
3-8d
16d AT 24" O.C.

	4'-	-0"	
	MIN	LA	١P
•	•	٥	][

to framing STUD DEPTH. 2x CRIPPLE\* 2-10d TN-2xBLK CONT

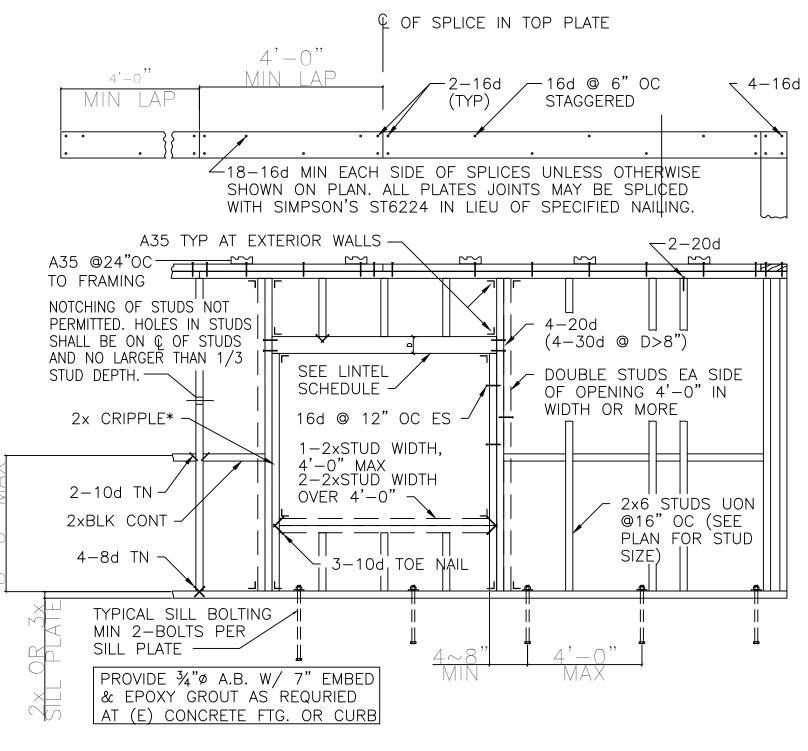



HEADER SCHEDULE							
SPAN	2'-0"	4'-0"	8'-0"	>8'-0"			
STUD	MAX	MAX	MAX				
2x4	2-2x4	2-2x6	4x8	SEE			
STUDS	OR 4x4	OR 4x6		NOTE 4			
2x6	3-2x4	3-2x6	6x8	SEE			
STUDS	OR 4x6	OR 6x6		NOTE 4			
2x8 STUDS	4x8	6x8	8x8	SEE NOTE 4			


ALL LINTELS ON EDGES EXCEPT WHERE NOTED, F WHERE THEY ARE FLAT.

<u>NOTE:</u>

- 1. USE 3x CRIPPLE WHERE SPAN EXCEEDS 6'-0", UON
- 2. WHERE LINTEL REPLACES ONE OF 2x TOP PLATES, LAP AND NAIL PLATE TO LINTEL SAME AS FOR PLATES.
- 3. AT BEARING WALL WITHOUT PLYWOOD SHEATHING INSTALL CONTINUOUS 2x BLOCKING AT 4'-0" OC MAX VERTICAL
- 4. FOR SPAN GREATER THAN 8'-0", SEE PLAN.

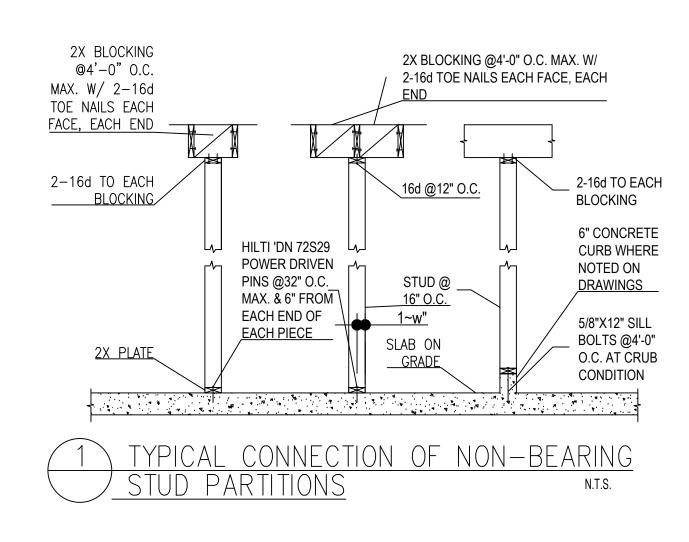


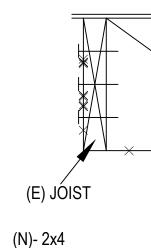

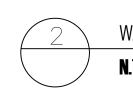


@16" O.C-

Α

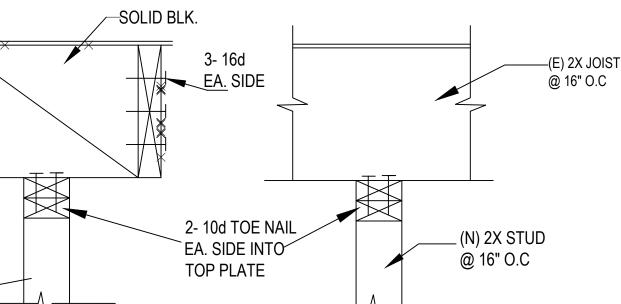



N.T.S

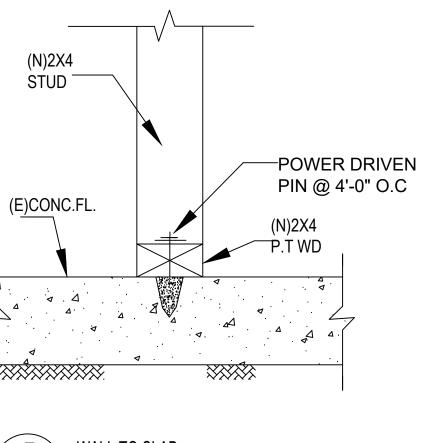


G

Н

J

K

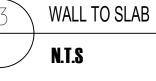


DEVELOPMENT LENGTHS SCHEDULE (Normal weight concrete)											
TENSION	f'c PSI	BAR SIZE GRADE 60	#3	#4	<b>#</b> 5	#6	#7	#8	<b>#</b> 9	#10	#11
GHT )	2500	TOP	24"	31"	40"	48"	69"	79"	88"	98"	108"
A & STRAIGHT ELOPMENT FHS, L (IN)	25	OTHER	18"	25"	30"	37"	53"	61"	69"	75"	83"
	3000	TOP	21"	28"	36"	43"	62"	71"	80"	89"	98"
	30	OTHER	16"	22"	27"	33"	48"	55"	62"	68"	75"
CLASS , DEV LENG 4000	4000	TOP	18"	25"	31"	37"	54"	62"	69"	77"	85"
CL CL	40	OTHER	14"	19"	24"	28"	42"	47"	53"	59"	65"
	500	TOP	31"	41"	51"	61"	90"	102"	115"	128"	140"
m	25	OTHER	24"	31"	40"	48"	69"	79"	88"	98"	108"
	3000	TOP	28"	37"	46"	55"	81"	92"	104"	116"	127"
CLASS	30	OTHER	21"	28"	36"	43"	62"	71"	80"	89"	98"
	4000	TOP	24"	32"	40"	48"	70"	80"	90"	100"	110"
	40	OTHER	18"	25"	31"	37"	54"	62"	69"	77"	85"

NOTE: PROVIDE 30% LONGER LAP LENGTH FOR LIGHT WEIGHT CONCRETE.


NOTES: 1. CLEAR SPACING OF BARS BEING DEVELOPED OR SPLICED SHALL BE NOT LESS THAN TWO BAR DIAMETERS AND CLEAR COVER SHALL NOT BE LESS THAN ONE BAR DIAMETER, AND STIRRUPS OR TIES THROUGHOUT "L" SHALL NOT BE LESS THAN THE PRESCRIBED MINIMUM.

2. ALL SPLICES SHALL BE CLASS B SPLICE, TYP, UNO. 3. PROVIDE 180° HOOK OR T-HEAD AT EDGE OF SLAB OR OPENING, TYP, UNO. 4. TOP BARS ARE HORIZONTAL REINFORCEMENT WITH MORE THAN 12" OF FRESH CONCRETE CAST BELOW BAR. THIS INCLUDES BEAMS, SLABS, FOUNDATION AND WALLS. 5. WHEN SPLICING DIFFERENT SIZED BARS, USE THE LONGER LENGTH OF (Ld OF THE LARGER BAR AND LAP SPLICE Lb OF THE SMALLER BAR). 6. NON-CONTACT LAP SPLICED BARS SHALL NOT BE SPACED TRANSVERSELY FURTHER APART THAN 20% OF THE REQUIRED LAP LENGTH OR 6 INCHES. 7. FOR I'C OF 2,500 PSI, USE SPLICE LENGTH VALUES FOR 3,000 PSI AND INCREASE THEM BY 15%.

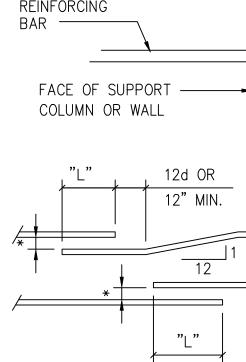

REINFORCING EXTEND BAR STRAIGHT U.O.N., BEND WHERE NECESSARY -TOP REINF. 1 MAX \_\_\_\_\_1 MAX ∠ BOTTOM REINF. BEAM COLUMN (OR WALL BOUNDARY \*1~8" OR TIRE WIRED IN CONTACT ÈLEMENT) BOUNDARY, COLUMN AND BEAM REINFORCING SPLICE DETAIL



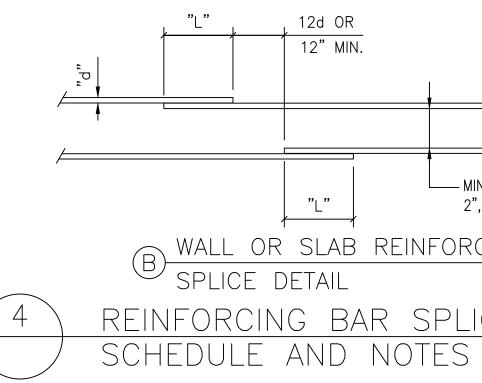


## REINFORCING BAR SPLICE AND STRAIGHT

12d OR 12" MIN. —— MIN 2 BAR DIAMETERS MIN "∟" 2", TYP, UNO. B WALL OR SLAB REINFORCING REINFORCING BAR SPLICE

М

N

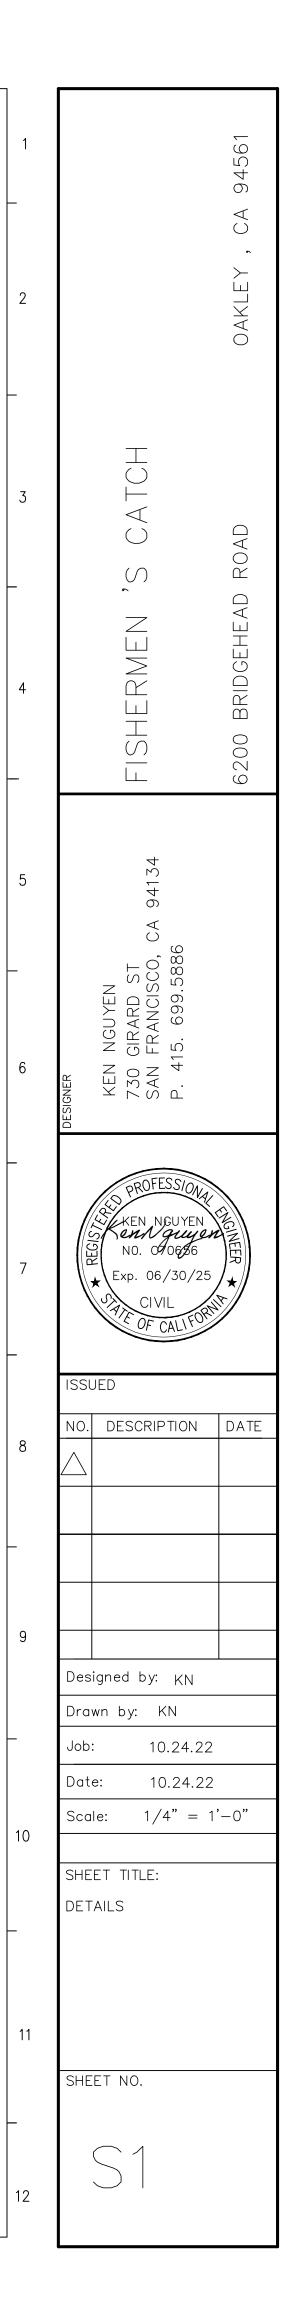

11

12

5

Γ				
	CALIFORNIA ENERGY COMMISSION	NRCC-LTI-E	(Page 5 of 8)	2024-06-03T15:03:00-04:00
			Report Page:	Date Prepared:
			Catch Lighting Alteration	
	STATE OF CALIFORNIA Indoor Lighting	CERTIFICATE OF COMPLIANCE	Project Name: Fisherman's Catch Lighting Alteration	

the second s	
and the second se	
1	S
ł	
ł	10
ł	ĪĨ
1	IF
ł	ш
ł	2
1	
	12
1	15
ł	1 Y
1	19
ł	12
1	17
ł	10
ł	
ł	
1	122
ł	15
1	
1	<b>DR AREA CATE</b>
j	10
ł	100
ł	$ \cong$
1	≤
ł	
ł	
ł	BUILDING
1	ເສ
1	
j	I۳
1	PLET
1	
1	0
j	5
ł	15
ł	19
	ACE: COMPLETE BUILDING OR AREA CATE
ł	1.63
ł	
ł	ĪŽ
j	0
ł	15
1	IS
j	-
ł	
ł	ER /
ł	
1	
1	15
	0
1	IGHTING POWI
	100
j	
ł	
ł	IF
j	ΙŦ
ł	C)
ł	1

I. LIGHTING POWER ALLOWANCE:	I. LIGHTING POWER ALLOWANCE: COMPLETE BUILDING OR AREA CATEGORY METHODS	<b>AETHODS</b>				
Arra Decerimenton	Complete Building or Area Category Primary	Allowed Density	Arce (42)	Allowed Wattage	Additional Allowance / Adjustment	nce / Adjustment
	Function Area	(W/ft <sup>2</sup> )		(Watts)	Area Category	PAF
Warehouse	Commercial Industrial Warehouse	0.4	5,790	2,316	No	No
Sales Area	Retail Merchandise Sales Wholesale Showroom	0.95	1,975	1,876.25	No	No
Breakroom	All Other Space Types	0.4	295	118	No	No
Office	Office ( <=250 square feet)	0.65	106	68.9	No	No
Restrooms - H'way	Restroom	0.65	290	188.5	No	No
Restroom - Electrical Rm	Restroom	0.65	73	47.45	No	No
		TOTALS:	8,529	4,615.1	See Tables J, or P for detail	or P for detail
					8	

- F

\_\_\_\_\_

K. T. This

エー

ITIONAL LIG

N. A This

R.

A

\_\_\_\_\_

uilding Energy Efficiency Standards - 2022 Nonresidential Compliance	Report Version: 2022.0.000	Compliance ID: 105792-062
	Schema Version: rev 20220101	Report Generated: 2024-06-03 12
		ŝ

		Report Page:	Date Prepared:
state of california Indoor Lighting	CERTIFICATE OF COMPLIANCE	Project Name: Fisherman's Catch Lighting Alteration	

(CHANDISE		AENT FACTOR (PAF))
O. ADDITIONAL LIGHTING ALLOWANCE: TAILORED VERY VALUABLE MERCHANDISE	This section does not apply to this project.	P. POWER ADJUSTMENT: LIGHTING CONTROL CREDIT (POWER ADJUSTMENT FACTOR (PAF))

STATE OF CALIFORNIA	
Indoor Lighting	CALIFORNIA ENERGY COMMISSION
CERTIFICATE OF COMPLIANCE	NRCC-LTI-E
This document is used to demonstrate compliance with requirements in 110.9, 110.12(c), 130.0, 130.1, 140.6 and 141.0(b)2 for indoor lighting scopes using the prescriptive path for	0.0, 130.1, 140.6 and 141.0(b)2 for indoor lighting scopes using the prescriptive path for
ponresidential and hotel/motel occupancies. It is also used to document compliance with requirements in 160.5, 170.2(e) and 180.2(b)4 for indoor lighting scopes using the prescriptive	uirements in 160.5, 170.2(e) and 180.2(b)4 for indoor lighting scopes using the prescripti
path for multifamily occupancies. Multifamily includes dormitory and senior living facilities.	
Project Name: Fisherman's Catch Lighting Alteration	Report Page: (Page 1 of 8)

Α

GENERAL INFORMATION	

	04 Total Conditioned Floor Area (ft <sup>2</sup> ) 8,529
02 Climate Zone 12	05 Total Unconditioned Floor Area (ft <sup>2</sup> ) 0
03 Occupancy Types Within Project (select all that apply):	06 # of Stories (Habitable Above Grade) 1
• Retail	

ш	
PROJECT SCOPI	
SC	
E	
õ	
E.	
B	L

141.0(b)2 / 180.2(b)4 for alterations.				
Scope of Work	Conditioned Spaces	Ş	Unconditioned Spaces	ces
01	02	80	04	05
My Project Consists of (check all that apply):	Calculation Method	Area (ft²)	Calculation Method	Area (ft <sup>2</sup> )
New Lighting System	N/A	ο	N/A	ο
New Lighting System - Parking Garage	N/A	0	N/A	0
🛛 Altered Lighting System	Area Category Method	8529	Area Category Method	0

Indoor Lighting		CALIFORNIA ENERGY COMMISSION
CERTIFICATE OF COMPLIANCE		NRCC-LTI-E
Project Name: Fisherman's Catch Lighting Alteration	Report Page:	(Page 2 of 8)
	Date Prepared:	2024-06-03T15:03:00-04:00

		Compliance Results	60		05 must be >= 08 140.6 / 170.2(e)	
		Adjusted Lighting Power per 140.6(a) / 170.2(e) (Watts)	08		Total Adjusted (Watts) *Includes Adjustments	
		r 140			11	
	dance.	tting Power per (Watts)	07	Adjustments	PAF Lighting Control Credits 140.6(a)2 / 170.2(e)1B	
	with Exceptional Conditions" refer to Table D. for guidance.	Adjusted Ligh	90		Total Designed (Watts)	
	er to				ΔΙ	
	onditions" refe	atts)	05		<b>Total</b> Allowed (Watts)	
ional C		Allowed Lighting Power per 140.6(b) / 170.2(e) (Watts)			Ĩ	
" or "COMPLIES with Exceptio	<sup>p</sup> ower per 140.6(b) / 170.2(e		ower per 140.6(b) / 170.2(e	04		Tailored 140.6(c)3 / 170.2(e)4B ( +)
				ower per 140.6	03	Area
	VOT COMPLY".	wed Lighting F	02		Area Category 140.6(c)2 / 170.2(e)4	
SULTS	e says "DOES h	Allo	01		Complete Building 140.6(c)1	
C. COMPLIANCE RESULTS	If any cell on this table says "DOES NOT COMPLY" or "COMPLIES		Lighting in	conattionea ana unconditioned	spaces must not be combined for compliance per 140.6(b)1 / 170.2(e)	

CALIFORNIA ENERGY COMMISSION         Report Page:       NRCC-LTI-E         NRCC-LTI-E       NRCC-LTI-E         Date Prepared:       2024-06-03115:03:00-04:00	le D. for guidance.       djusted Lig/Hting Power per 140.6(a) / 170.2(e)       06     07     08       06     07     08       06     07     08       140.6(a)2 / watts)     140.6(a)2 / watts)       140.6(a)2 / watts)     140.6(a)2 / watts)       06     07     08       07     08     140.6(a)2 / watts)       140.6(a)2 / watts)     140.6(a)2 / watts)     140.6(a)2 / watts)       08     140.6(a)2 / watts)     140.6(a)2 / watts)       09     07     08     2800       2,000     140.6(a)2 / watts)     140.5(a)2 / watts)       2,800     2,800     2,800       2,800     2,800     2,800       2,800     2,800     2,800       2,800     2,800     2,800       2,800     2,800     2,900       2,800     2,900     2,900       2,900     2,800     2,900       2,900     2,800     2,900       2,900     2,800     2,900       2,900     2,800     2,900       2,900     2,900     2,900       2,900     2,900     2,900       2,900     2,900     2,900       1,1,0,0,0,0,0,0     2,900	Generated Date/ lime: Documentation Software: Energy Code Ace Report Version: 2022.0.000 Compliance ID: 105792-0624-0019 Schema Version: rev 20220101 Report Generated: 2024-06-03 12:03:02	CALIFORNIA ENERGY COMMISSION         Report Page:       NRCC-LTI-E         NRCC-LTI-E       NRCC-LTI-E         Date Prepared:       2024-06-03115:03:00-04:00	FINDOOR LIGHTING FRTURE SCHEDULE         This table includes of promedy more than overling unit/ note! more finag unit and hote/more! room lighting is continues of provisions for Ming, earling unit and hote/more! room lighting is not commended in multiformity dwelling unit and hote/more! room lighting is not commended in table 1.1 y using Table 1.1	See Area/Space Level Controls     Image: Control controls       Generated Date/Time:     Documentation Software: Energy Code Ace       Report Version: 2022.0.000     Compliance ID: 105792-0624-0019       Schema Version: rev 20220101     Report Generated: 2024-06-03 12:03:02
STATE OF CALIFORNIA Indoor Lighting CERTIFICATE OF COMPILANCE Project Name: Fisherman's Catch Lighting Alteration	C. COMPLIANCE RESULTS         If any cell on this table says "DOES NOT COMPLY" or "COMPLIES will represent the says "DOES NOT COMPLY" or "COMPLIES will represent the same spaces must not be unconditioned and unconditioned and unconditioned and unconditioned and unconditioned and unconditioned and unconditioned complexe because per 140.6(c)1       Allowed Lighting Power per 140.6(c)2 / 170.2(e)4ds v (+)         140.6(b)1 / 170.2(e)       140.6(c)1       170.2(e)4ds v (+)       (+)         140.6(c)1       170.2(e)4ds v (+)       (+)       (+)         Unconditioned       4,615.1       170.2(e)4ds v (+)       (+)         Difficitioned       4,615.1       170.2(e)4ds v (+)       (+)         Inconditioned       4,615.1       170.2(e)4ds v (+)       (+)         Instable is auto-filled with uneditable comments because of selection for the four the fou	CA Building Energy Efficiency Standards - 2022 Nonresidential Complianc	STATE OF CALIFORNIA Indoor Lighting CERTIFICATE OF COMPLIANCE Project Name: Fisherman's Catch Lighting Alteration	F. INDOOR LIGHTING FIXTURE SCHEDULE         This table includes all planned permanent and portable lighting or documented in Table T. If using Table T to document lighting in mul not included here.         Designed Wattage: Conditioned Spaces       03       5         01       02       03       5         Name or Item       Complete Luminaire       Modular       5         UT1       5" UFO HB LED Lights       No       1         LT2       Recessed Celling Lights       No       1         LT3       2X4 Fluorescent Lights       No       1         LT3       2X4 Fluorescent Lights       No       1         LT3       2X4 Fluorescent Lights       No       1         POOTNOTE: Design Watts for small aperture and color changing lu utomatically makes this adjustment, the permit applicant should a utomatically makes this adjustment, the permit applicant should a utomatically makes this adjustment, the permit applicant should a "POOTNOTE: Design Watts for small aperture and color changing lu utomatice, not the lamp.         Pauthority Having Jurisdiction may ask for Luminaire cut sheets to the minaire, not the lamp.       Initia spolect.         This section does not apply to this project.       Initia section does not apply to this project.       Initis table includes lighting controls for conditioned and unconditioned in unconditioned in unconditioned in unconditioned in unconditioned in uncondititored in uncondititored in unconditioned in unconditioned in unco	NA < 4,000W subject to multilevel CA Building Energy Efficiency Standards - 2022 Nonresidential Compliance
CALFORNIA ENERGY COMMISSION NRCC-LTI-E (Page 6 of 8) 2024-06-03T15:03:00-04:00	ation si	Documentation Software: Energy Code Ace Compliance ID: 105792-0624-0019 Report Generated: 2024-06-03 12:03:02	CALIFORNIA ENERGY COMMISSION NRCC-LTI-E (Page 7 of 8) 2024-06-03T15:03:00-04:00	in table E.         in the form name must be completed through an Acceptance iders.html         Systems/Spaces To Be Field Verified         Sales Area; Breakroom;         Office; Restrooms - H'way ;         Restroom - Electrical Rm	Documentation Software: Energy Code Ace Compliance ID: 105792-0624-0019 Report Generated: 2024-06-03 12:03:02
Lighting Alteration Bate Prepared:	CE: TAILORED VERY VALUABLE MERCH	gy Efficiency Standards - 2022 Nonresidential Compliance Report Version: 2022.0.000 Schema Version: rev 20220101	ANCE Report Page: man's Catch Lighting Alteration Date Prepared:	V. DECLARATION OF REQUIRED CERTIFICATES OF ACCEPTANCE         Selections have been adomed based on proform of the nitid grapment. If any selections have been changed by the permit applicant, on extandinonal lemanks. These documents must be building inspector during construction and any with "4" in the form name must test Technician Certification Povider (ATTCP). For more information wist: http://www.energy.co.gov/title24/attcp/providers.html         INRCA.TI-02-A - Must be submitted for occupancy sensors and automatic time switch controls.	Generated Date/Time: CA Building Energy Efficiency Standards - 2022 Nonresidential Compliance Report Version: 2022.0.000 Schema Version: rev 20220101
STATE OF CALIFORNIA Indoor Lighting CERTIFICATE OF COMPLIANCE Project Name: Fisherman's Catch Lighting Alteration	O. ADDITIONAL LIGHTING ALLOWANCE: TAILORED VERY V         This section does not apply to this project.         P. POWER ADJUSTMENT: LIGHTING CONTROL CREDIT (PO         This section does not apply to this project.         U. DECLARATION OF REQUIRED CERTIFICATES OF INSTALL         Selections have been made based on information provided in thi         Additional Remarks. These documents must be provided to the b         NRCI-LTI-E - Must be submitted for all buildings.	CA Building Energy Efficiency Standar	STATE OF CALIFORNIA Indoor Lighting CERTIFICATE OF COMPLIANCE Project Name: Fisherman's Catch	V. DECLARATION OF REQUIRED Selections have been made based Additional Remarks. These docum Test Technician Certification Provic NRCA-LTI-02-A - Must be submitte	CA Building Energy Efficiency Standa

Η

J

F I G H I J

				state of california Indoor Lighting		CALIFORNIA ENERGY COMMISSION	STATE OF CALIFORNIA Indoor Lighting					CALIFORNIA ENERGY COMMISSION
				З I	Renort Dage.	NRCC-LI1-E (Date 8 of 8)	Ŭ	l lighting Alteration		Renort Dage.		NRCC-LITE (Date A of 8)
				2685 Leland Roafd, Pittsburgh,	Date Prepared:	-03T15		0		Date Prepared:		2024-06-03T15:03:00-0
							H. INDOOR LIGHTING CONTR	<b>DLS (Not including PAFs)</b>				
					te and complete.		Area Level Controls					
				Merlin C	Documentation Author Signat.	Marlin C. C	04	05	90			
				Mc2 Endi	Signature Date:	J J P DC-EU-9U			Manual Area			Interlocked
				35 Stone	CEA/ HERS Certification Identif	fication (if applicable):		Complete Building or Area	Controls			
				San Franc	Phone:	415-216-9620	Area Description	category Primary Function Area	130.1(a) /			
				RESPONSIBLE PERSON'S DECLARATION STATEMENT					160.5(b)4A			170.2(e)2A Pass
				I certrity the rollowing under penality or perjury, under the laws of the state of california: 1. The information provided on this Certificate of Compliance is true and correct.				Commercial Industrial			NA: <= 80 % NA: <= 80 %	[ :
					rsibility for the building design or system design ide		Warehouse	Warehouse		10.00	LP (alt only) LP (alt only)	No
The contract of the contr					nanufactured devices for the building design or syst	tem design identified on this Certificate of Compliance conform to the requirements	Salas Araa	Retail Merchandise Sales	Readily		NA: Not NA: <= 80 %	
Contract and a state of the state of					of Compliance are consistent with the information	· provided on other applicable compliance documents, worksheets, calculations,		Wholesale Showroom	Accessible		daylit zone LP (alt only)	]
					is building permit application. made available with the building permit(s) issued f	for the building, and made available to the enforcement agency for all applicable	Breakroom	All Other Space Types	Readily Accessible			
			Image: contract of the state of the stat	inspections. I understand that a completed signed copy of this Certificate of Compliai	ance is required to be included with the document	tation the builder provides to the building owner at occupancy.	-		Doodily		-	
					Responsible Designer Signatur	Cen A	Office	Office ( <=250 square feet)	Accessible	20024.0		
Manual Manua Manual Manua Manual Manual Manual Manual Manual Manual Manual Ma		Automatic     Autom	Image: Transmission of the second		neu.		1	in a			+	[
Autors literation     Autors literation     Autors literation     Autors literation     Autors literation     Autors literation     Autors     Autor		A Secret Intervention of the secret interve	Image: Second			386	Kestrooms - H way	Kestroom				
3       HOLES       S       HOLES       HOLE			3       CUU				Restroom - Electrical Rm	Restroom			-	
HUNCH Sector control of the sector of the	2       2       All     All     All       Image: State of the state						Accessible		-	ç
Image: Second		THE PLACE CONTRACT CO									Dlan Chee	+ Showing Davlit Zonas
a       H       H       H       H         a       B       H       H       H       H         b       B       H       H       H       H       H         c       B       H       H       H       H       H       H         c       B       H       H       2       2       4       1       1         3       1       1       1       1       1         1       1       1       1       1       1       1	3       COURT ALL OWNER AL	Image: State									
Interest Function       Interest Function       Interest Function       Interest Function         1       1       Image: Second	Image: Second control of the second	THE PROPERTY OF THE PROPERTY									
Bell of the second			10       10       <td< td=""><td></td><td></td><td></td><td></td><td></td><td></td><td></td><td></td><td></td></td<>									
All HEARD France in the second of the second		Image: State Stat	And the construction of th					VCE: COMPLETE BUILDING (	UK AKEA CAI EGU			
A HOLD CS. HEAD IN CO. C.	Image: Second Control of Co	Image: Second contract statute and st	A Construction of the second relation of the				Each area complying using the C	omplete Building or Area Categ	ory Methods per 14	0.6(b) are included in this table. Co	olumn 06 indicates if additior	nal lighting power allowances per
3     3     U       3     1       3     1       3     1       3     1       4     1       4     1       5     1       5     1       6     1       7     1       10     1       10     1       10     1       10     1	2     2     2       2     2     2       3     3     3       4     3     3       4     3     3       5     1       5     1       7     1       7     1       7     1       10     1       11     1	8     HIDDEL       8     HIDDEL       3     HIDDEL       8     HIDDEL       9     HIDDEL       9     HIDDEL       10     HIDDEL       11     HIDDEL	Bell of the first of the second				14U.b(c) of adjustments per 14U.	o(a) are peing usea .				
S UPD C C C Province Level 100 C C C C C Province Level 100 C C C C Province Level 100 C C C C C C C C C C C C C Province Level 100 C C C C C C C C C C C C C C C C C C	2 HOLDER CONTRACT STATE OF STA	8       HOLLS         3       HOLLS         4       HOLLS         4       HOLLS         5       HOLLS         5       HOLLS         6       HOLLS         7       HOLLS         7       HOLLS         8       HOLLS         10       HOLLS         10       HOLLS         11       HOLLS	Contracting and structure factors and s						, ,		JE DE	UE
B B B B B B B B B B B B B B	2       HOLESCHERENCY         3       HOLESCHERENCY         3       HOLESCHERENCY         4       HOLESCHERENCY         4       HOLESCHERENCY         5       HOLESCHERENCY         5       HOLESCHERENCY         6       HOLESCHERENCY         7       HOLESCHERENCY         7       HOLESCHERENCY         8       HOLESCHERENCY         10       HOLESCHERENCY         10       HOLESCHERENCY         11       HOLESCHERENCY	B B B B B B B B B B B B B B	B     Construction     Construction       Construction     Construction       Construction				10		4		3	3
And A Construction of the second states and	2       2       3       HOLES       4         3       4       HOLES       5       NUMERIA         4       HOLES       10       10       10         100       10       10       10       10       10         100       10       11       11       11       11	а	The first of the construction of the construct		E C						6	
The contract of the contract o	21       2       3       HOUSE000000000000000000000000000000000000	3     HOLESSing       3     HOLESSing       4     HOLESSing       4     HOLESSing       5     FELHOR       7     Sourcesson       8     HOLESSing       8     HOLESSing       9     Designed by:       10     FEED TITLE:       11     HEEP TITLE:	All the construction of th		Generated Date/ Lime:	Documentation Software: Energy Lode Ace				Generated Date/ IIme:		vocumentation sortware: Energy Code
3       HOLES         3       HOLES         4       HULES         5       NETHON         6       HULES         7       FEINOR         8       NO         9       Designed by: KN         0bit: 06.24.24         0bit: 06.24.24         Scole: NTS         10         11	2       HOLESSION         3       HOLESSION         4       HUDESSION         5       ************************************	3       HOLESSON         4       HULES         5       VIII         6       VIIII         7       VIIIII         8       NO         9       Designed by: KN         Job:       06.24.24         Scole:       NTS         10       Sheet Title:         11       Item of the point	A A A A A A A A A A A A A A	CA Building Energy Efficiency Standards - 2022 Nonresidential Compliance	Report Version: 2022.0.000	Compliance ID: 105792-0624-0019	CA Building Energy Efficiency Stand	ards - 2022 Nonresidential Compli	ance	Report Version: 2022.0.000		Compliance ID: 105792-0624-0
3       HOLKO         3       C         4       HULKO         5       NUMALINA         6       NUMALINA         7       ISSUED         8       NO         9       Designed by: KN         Job:       06.24.24         Scale:       NTS         10       SHEET TITLE:         11       Item of the second	3     HOLYO       3     HOLYO       4     HOLYO       5     NUMMER       6     NUMER       7     VERTICESSON       8     NO       NO     DESCRIPTION       9     Designed by: KN       Date:     06.24.24       Date:     06.24.24       Scale:     NTS       10     SHEET TITLE:       11     ITTLE-24 REPORT	2 HOLYO CONTRACTOR CON	2 HEET TITLE: 3 HEET TITLE: 1 HI 4 HI 4 HI 5 HEET TITLE: 11 HI 4 HI 5 HEET TITLE: 11 HI 11		Schema Version: rev 20220101	Keport Generated: 2024-06-03 12:03:02				Schema Version: rev 20220101		Keport Generated: 2024-06-03 12:0
3       HOLYO         3       HOLYO         4       HUHYO         5       NUMATION         6       NUMATION         7       ISSUED         8       ISSUED         9       Designed by: KN         Job:       06.24.24         Scale:       NTS         10       SHEET TITLE:         11       INTERPORT	3       HOLYON         3       HOLYON         4       HUNDER         5       F146         5       F146         6       HUNDER         8       HOLYON         9       Designed by: KN         10       SHEET TITLE:         11       HUNDER	2       HOLVO         3       HOLVO         4       HOLVO         5       F11         6       HOLVO         7       F11         9       Designed by: KN         10       SHEET TITLE: TITLE-24 REPORT         11       It	2 HITTLE: 3 HITTLE: 4 HITTLE: 5 HITTLE: 10 Designed by: KN Designed b									
$     \begin{array}{c}                                     $	2 3 4 4 4 4 4 10 5 5 6 10 10 10 10 10 10 10 10 10 10	2 HOLESCIPTION DA 3 HOLESCIPTION DA 4 HOLESCIPTION DA 5 NO. DESCRIPTION DA 8 NO. DESCRIPTION DA 9 Designed by: KN Job: 06.24.24 Scale: NTS 10 SHEET TITLE: 11 SUED	2 HOY NOT HELL AND									
Image: Second system       1000000000000000000000000000000000000	HOLO S NUMA HOLO S NUMA HOLO S NUMA HOLO S NUMA HOLO S NUMA HOLO S NUMA HOLO S NUMA S S S NUMA HOLO S S NUMA HOLO S S S S S S S S S S S S S S S S S S	HOLESSIONER HOLESSIONER HOLESSIONER KEN NGUYEN SAN EXPLOSION DA SAN EXPLOSION DA SAN EXPLOSION DA SAN EXPLOSION DA NO. DESCRIPTION DA SAN EXPLOSION DA Designed by: KN Drawn by: KN Job: 06.24.24 Scale: NTS SHEET TITLE: TITLE-24 REPORT	Designed by: KN Drawn by: KN Designed by: KN Designed by: KN Drawn by:	-	9		6	5	_	4	3	2
SUED DESCRIPTION SUED DESCRIPTION SUED DESCRIPTION A DESCRIPTION CIVIL DESCRIPTION CIVIL CIVIL CF CALLFORM CALLFORM COSSIDE CIVIL CF CALLFORM CALLFORM CIVIL CF CALLFORM CIVIL CF CALLFORM CIVIL CIVIL CF CALLFORM CIVIL CIVIL CF CALLFORM CIVIL CIVIL C	HOLVO SUED SUED DESCRIPTION SUED DESCRIPTION DESCRIPTION CIVIL NO. CHOESE SUED DESCRIPTION CIVIL NO. CHOESE SUED DESCRIPTION DESCRIPTION CIVIL SUED DESCRIPTION DESCRIPTION CIVIL SUED DESCRIPTION CIVIL CIVIL SUED DESCRIPTION CIVIL CIVIL CIVI	HOLUGION SUED SUED CONTRACTION SUED CONTRACTION CONTRACTION CONTRA	COVERNMENT CONCEPTION CONCEPTION CONCEP	Jc Dc Sc TI	_		DESIGNER					
412       412         412       000000000000000000000000000000000000	KEN NGUYEN C C C C C C C C C C C C C	HOLDO CON CALLER HEN NGULEN SAN FRANCISCO, CALLER HEN NGULEN SAN FRANCISCO, CALLER HEN NGULEN NO. CROSSO EXP. 06/30/25 SAN FRANCISCO, CALLER MARKEN NGUYEN NO. CROSSO EXP. 06/30/25 SAN FRANCISCO SAN FRANCISCO CIVIL MARKEN NGUYEN NO. CROSSO EXP. 06/30/25 SAN FRANCISCO SAN FRANCISCO CIVIL MARKEN NGUYEN NO. CROSSO EXP. 06/30/25 SAN FRANCISCO SAN	ADVICE ALL AND ADVICE AND ADVICE AND ADVICE AND ADVICE AND ADVICE AND ADVICE AD	ate cali HEE TLE		SU						
12       9882.669       9982.669         12       02       02         13       02       02         14       02       02         15       04       02         15       04       02         15       04       02         15       06       02         16       06       06         17       06       06         16       by:       KN         17       06       06         17       06       06         17       06       06         17       06       06         17       06       06         17       06       06         17       06       06         17       06       06         17       06       06         17       06       06         17       06       06         17       06       06         17       06       06         17       06       06         17       06       06         17       06       06         18       06	HOLO S. NJWAJHSI S. NJWAJHSI S	HOLUG CUALTON DA S NUMBER OF STOLEN NO. CHANCISCO, CALTON KEN NGUYEN NO. CHOESE SAN FRANCISCO, CA 94134 NO. CHOESE SAN FRANCISCO, CA 94134 CIVIL PROFESSION KEN NGUYEN NO. CHOESE SOF CALTON S NUMBER NO. CHOESE S NUMBER NO. CHOESE S NUMBER NO. CHOESE S NUMBER NO. CHOESE S NUMBER S NUMBER NO. CHOESE S NUMBER	OAKLEY CONTENT CONTENT CONT	e: ET E—		IED						
121       121         1	Image: State of the state	Image: State of the state	OGVIEV OAKLEY CONCEPTION CONCEPTION CO	TI1 24			730 GIRARD					
PESSIONAL PESSIONAL NGUYEN CTOOSE 6/30/25 VIL PTION IPTION CALLFORM CONSTRUCTION CALLFORM CONSTRUCTION CALLFORM CONSTRUCTION CALLFORM CONSTRUCTION CALLFORM CONSTRUCTION CALLFORM CONSTRUCTION CALLFORM CONSTRUCTION CONSTRUCTION CALLFORM CONSTRUCTION CONSTRUCTION CONSTRUCT	IPTION       D	HOTO OUT UND HOTO OUT UND HO	OVER VIEW VIEW VIEW VIEW VIEW VIEW VIEW VIEW	( N TLE R		EN 2. 0 . 0 . 0 . 0					AIUT	
0 0 0 0 0 0 0 0 0 0 0 0 0 0 0 0 0 0 0	00000000000000000000000000000000000000	N     N       N     N	OAKLEY OAKLEY OA	D6.2 D6.2 TS		NGL CZO 6/3 VIL	D 115 FOO FEE					
24			OAKLEY DATE TALENTIER TALENTER TALENTER TALENTER TALENTER TALENTER	24.2		JYEN 6550 50/2	. 1 					
		A A A A A A A A A A A A A A A A A A A	6220 BRIDGEHEAD ROAD OAKLEY			<b>en</b>						

М

N

K

\_\_\_\_\_ M\_\_\_\_\_

Ν

I K

	ION MEASURES:         COMPONENTS         COMPONENTS         COMPONENTS         COMPONENTS         COMPONENTS         COMPONENTS         COMPONENTS         CONFORCES SHALL IMEET THE APPLICABLE REQUIREMENTS OF 110.9.1         MEMBERS THE 2000 FT2 THRESHOLD.         REMENTS         VALABELED PER 13000FS         STERNS (EMICS) SHALL IMEET REQUIREMENTS OF 130.0.6.1         STERNS (EMICS) SHALL IMEET REQUIREMENTS OF 130.0.6.1         STERNS (EMICS) SHALL IMEET REQUIREMENTS OF 130.0.6.1         STERNS (EMICS) SHALL IMEET REQUIREMENTS OF 110.0.1         STERNS (EMICS) SHALL IMEET REQUIREMENTS OF 110.0.1         STERNS (EMICS) SHALL PARE LIGHTING FOR VIENTING ID BE MANUALIY TURNED ON LIGHTING OF REQUIREMENT         STERNS (EMICS) SHALL PARE LIGHTING FOR CONTROLS THAT ALLOW LIGHTING OF SOLAT TYPE CAN BE TURNED ID.1.1.1.1.1.1.1.1.1.1.1.1.1.1.1.1.1.1.1	Ideory Medistines: Turber Coccumant senses Turber Coccumant senses Turber Coccumant senses Turber Coccumant senses Turber Cocumant senses Turber Commed. Turber Commed. The Example of Automonter Lightmic when the The Control. Zone is unoccumed predi- tions. The Example of Automonter Lightmic when the The Control. Zone is unoccumed predi- tions. The Example of Automonter Senses of the Control. Zone is unoccumed predi- tions. The Example of Automonter Senses of the Control. Zone is unoccumed predi- ations. The Example of Automonter Senses of the Control. Zone is unoccumed predi- ations. The Example of Automonter Senses of the Control. Zone is unoccumed predi- ations. The Example of Automonter Senses of the Control of Countrol of Countr	<b>Iddrory Measures:</b> <b>Oddrory Measures:</b> <b>Oddrory Measures:</b> <b>Main</b> <b>Main</b> 1     1       2     1       3     1       4     1       5     1       4     1       5     1       6     1       1     1       1     1       2     1       3     1       4     1       1     1       5     1       1     1       1     1       1     1       1     1       2     1       1     1       1     1       2     1       2     1       3     1       1     1       2     1       2     1       3     1       3     1       4     1       1     1       5     1       1     Image: Drawn by:         KN           Job:         O6           Drawn by:         KN           Scale:         NTS           State T TITLE:         SHEET TITLE:	Indoor Lighting Mandatory Mea. 110.9 LIGHTING CONTROL ENVERSAND SYERK, NOTE: THE EXCEPTES SPACES NO OF CONTROL 130.0 GENERAL LUMINAIRE REQUIREMENTS 140.1 LUMINAIRE SHALLE FOR TORY LABELLED 140.1 LUMINAIRE REQUIREMENTS 140.1 LUMINAIRE REQUIREMENTS 141.1 LUMINAIRE REQUIREMENTS 141.1 LISTALLED INDOOR LIGHTING CONTROL OF GENERAL HAL 141. INSTALLED INDOOR LIGHTING SHALL ENCLOSED AREA 141. INSTALLED INDOOR LIGHTING SHALL ENCLOSE 141. INSTALLED INDOOR LIGHTING SHALL ENCLOSE 141. INSTALLED INDOOR LIGHTING SHALL ENCLOSE 141. INSTALLED INDOOR LIGHTING SHALL BE ENCLOSED 141. INSTALLED INDOOR LIGHTING SHALL BE ENCLOSED 140.1 INSTALLED INDOOR LIGHTING SHALL BE ENCLOSED 140.1 INSTALLED INDOOR LIGHTING SHALL BE ENCLOSED 140.1 INSTALLED INDOOR LIGHTING SHALL BALL BALLED 141. INSTALLED INDOOR LIGHTING SHALL BALLED 140.1 INTERED INDOOR LIGHTING SHALL BALLED 140.1 INTERED	hting Manc Urred Use of Fu Upant Sensing Ippose Rooms of Sor. Ind or Full-Off Any Size Oms of any Size Oms of any Size Oms of any Size Sor. Ind or Full-Off Ial or Full-Off Ays and Open a Book Stack als Creater Than, Greater Than,	Indoor Lighting Mai 130.1(f) Control Interact Each Lighting Control In Section. 1. For General Lighting, N Section. 1. For Sensing Control Lig	6 7 7 7 7 7 7 7 7 7 7 7 7 7
				Date: 06.24.2 Scale: NTS

### Attachment 5 **Development Review Design Guidelines** 2685 E. Leyland Road, AP-24-0085 (AUP, DR)

Section III: Multi Family	Project Complies?	If Not, Why?
<b>III.a:</b> A/C units should be substantially screened from view by way of permanent screen or appropriately sized plant material.	☐ Yes ☐ No ☐ COA ⊠ N/A	
<b>III.e:</b> Parking lots should not dominate area adjacent to public streets. Structures and parking should be interspersed creating pockets of parking and variety from a streetscape point of view.	☐ Yes ☐ No ☐ COA ⊠ N/A	
<b>III.f:</b> Trash enclosures should include area for collection of recyclables (example: space for two 90 gallon containers minimum, See Appendix #2 Trash Enclosure Design Standards)	☐ Yes ☐ No ☐ COA ⊠ N/A	
Commercial Design Guideline No.:	Project Complies?	If Not, Why?
<b>IV.a:</b> Parking areas should be screened from view from any public right-of-way. Parking areas should be broken up to eliminate vast areas of parking especially along street frontages.	⊠ Yes □ No □ COA ⊠ N/A	Existing open parking to be maintained.
<b>IV.c:</b> Existing trees on site should be incorporated into the project site design, unless waived by the City Planner or Planning Commission.	│	
<b>IV.d:</b> Developer should screen all utility box transformers, backflow preventers, meters, and junction boxes.	⊠ Yes □ No □ COA □ N/A	
<b>IV.f:</b> Continuous horizontal roof lines should be broken up whenever possible.	☐ Yes ☐ No ☐ COA ⊠ N/A	
<b>IV.g:</b> Building entries should be designed as a focal point. They should be designed to set the theme or be the primary feature of the building or commercial center.	☐ Yes ☐ No ☐ COA ⊠ N/A	
<b>IV.h:</b> Building elevations visible from public right-of-ways should be addressed in design review and treated appropriately.	⊠ Yes □ No □ COA □ N/A	
<b>IV.j:</b> All roof mounted equipment should be screened completely from view from all public	⊠ Yes ∏ No	

right-of-ways. A site-line study may be necessary to determine appropriate screening method.	☐ COA ☐ N/A	
<b>IV.k:</b> All structures including, but not limited to, 'tilt-up' type structures, should have structural reliefs and articulated entries.	⊠ Yes □ No □ COA □ N/A	
<b>IV.m:</b> Downspouts should be designed into the façade of the building unless architecturally treated.	<ul> <li>☐ Yes</li> <li>☐ No</li> <li>☐ COA</li> <li>☐ N/A</li> </ul>	
<b>IV.p:</b> New or remodeled buildings should be designed to be compatible in design, color and materials with adjacent development.	⊠ Yes □ No □ COA □ N/A	
<b>IV.q:</b> The street-oriented elevations shall be designed so as not to present the appearance of a rear elevation.	⊠ Yes □ No □ COA □ N/A	
<b>IV.r:</b> Trash enclosures should include area for collection of recyclables (i.e. space for two 90-gallon containers minimum).	⊠ Yes □ No ⊠ COA □ N/A	

Green Building Guideline No.:	Project Complies?	If Not, Why?
<b>VI.C.1:</b> Residential buildings without solar energy systems, roof surface should be covered with a green/living roof (>/= 50% of roof surface) or with a cool roof.	☐ Yes ☐ No ☐ COA ⊠ N/A	-
<b>VI.C.2:</b> Uncovered rooftop expanses greater than 200 square feet should be designed to be strong enough to support green roof s, community gardens, raised beds, and be accessible to occupants for gardening purposes.	☐ Yes ☐ No ☐ COA ⊠ N/A	
VI.C.3: Roofs should have solar hot water systems (panels), solar photovoltaic panels or low-profile wind turbines and should include a sustainable plan for maintenance of such systems. Roofs should be covered with a cool roof under the energy generation structures. Roof segments that are uncovered by energy systems should host raised bed garden space	☐ Yes ☐ No ☐ COA ⊠ N/A	

or greenhouses, a green/living roof, or cool roof surfaces.		
<ul> <li>VI.C.4: Parking lot impacts should be minimized.</li> <li>a. More than 20 spaces.</li> <li>b. Urban heat island impacts should be minimized through the use of shading (parking lot trees) or paving material design choices.</li> </ul>	☐ Yes ☐ No ☐ COA ⊠ N/A	Shading trees are along the sides of the parking lot. The parking lot has less than 20 spaces.
<b>VI.C.5:</b> Electric vehicle charging units should be made available to tenants with electric vehicles. The parking spaces with charging units should be clearly marked with signs designating them for assigned tenants or electric vehicle use only.	☐ Yes ☐ No ☐ COA ⊠ N/A	
<b>VI.C.6:</b> Pedestrian and bicycle path should provide safe, visible, and unobstructed bicycle and pedestrian access between facilities, from entrances to bicycle and pedestrian routes (sidewalks and bicycle lanes), through parking lots, and between facilities and existing or planned bicycle and pedestrian routes.	⊠ Yes □ No □ COA □ N/A	
<b>VI.C.7:</b> Convenient, visible and secure bicycle storage facilities should be available on site, sufficient to accommodate demand of residents and guests.	☐ Yes ☐ No ⊠ COA ☐ N/A	
<ul> <li>VI.C.8: Outdoor design and features should maximize landscaping water conservation.</li> <li>a. City or State water efficient landscape ordinance</li> <li>b. Incorporate community garden as amenity for tenants</li> <li>c. Permeable hardscape consistent with C.3 of NPDES regulations</li> <li>d. Incorporate a rain garden to utilize rainwater generated by majority of available roof area.</li> </ul>	☐ Yes ☐ No ⊠ COA ☐ N/A	
<b>VI.D.1:</b> Roofs should be designed to integrate renewable energy systems and provide a cool urban environment.	<ul> <li>✓ Yes</li> <li>☐ No</li> <li>☐ COA</li> <li>☐ N/A</li> </ul>	
<b>VI.D.2:</b> Urban heat island impacts should be minimized.	⊠ Yes □ No □ COA □ N/A	
<b>VI.D.3:</b> Hardscapes should be constructed with permeable surfaces. Impermeable surfaces	☐ Yes ☐ No	

may be used if they direct all runoff toward an appropriate permanent infiltration feature.	⊠ COA □ N/A
<b>VI.D.4:</b> Design choices should incorporate or prepare for electric vehicle charging or used vegetable oil fueling infrastructure.	☐ Yes ☐ No ☐ COA ⊠ N/A
<b>VI.D.5:</b> Fuel cell technology should be considered where other renewables are infeasible.	☐ Yes ☐ No ☐ COA ⊠ N/A
<b>VI.D.6:</b> Reclaimed water should be used for as much non-potable water uses as feasible and practical.	☐ Yes ☐ No ☐ COA ⊠ N/A
<b>VI.D.7:</b> Large commercial and institutional facilities that are anticipated to employ more than 50 employees should consider providing on-site shops and services for those employees.	☐ Yes ☐ No ☐ COA ⊠ N/A
<b>VI.D.8:</b> Street side building faces should encourage walking.	<ul> <li>☐ Yes</li> <li>☐ No</li> <li>☐ COA</li> <li>☐ N/A</li> </ul>
<b>VI.D.9:</b> Secure bicycle parking facilities should be provided for at least 10 percent of expected peak hour trips.	☐ Yes ☐ No ⊠ COA ☐ N/A



## **NOTICE OF PUBLIC HEARING**

NOTICE IS HEREBY GIVEN that the ZONING ADMINISTRATOR of the City of Pittsburg will conduct a public hearing on:

DATE:	October 9, 2024
TIME:	1:30 PM
PLACE:	First Floor, Conference Room 4B
	65 Civic Avenue, Pittsburg, California

Concerning the following matter:

### Fisherman's Catch, 2685 E. Leyland Road, AP-24-0085 (UP, DR)

Application for Administrative Use Permit (UP) and Administrative Design Review (DR) to establish a seafood processing operation with a specialization in high-quality crab products (light manufacturing) and grocery store (food and beverage sales) establishment within existing commercial building located at 2585 E. Leyland Road, Pittsburg, CA 94565.

The site is classified "Employment Center Industrial" in the Pittsburg General Plan land use map and zoned "Limited Industrial with Overlay (IL-O)".

Assessor's Parcel Nos. 088-152-017

This project is delegated to the Zoning Administrator under PMC Section 18.10.050 and 18.28.020(B).

PROJECT PLANNER: Maurice Brenyah-Addow, (925) 252-4261 or mbrenyah-addow@pittsburgca.gov.

#### Why am I receiving this notice?

You are receiving this notice because you have either previously requested notifications from the Planning Division, or a project has been proposed in your neighborhood and all property owners within a minimum 300-foot radius of the project site are required to be notified under the Pittsburg Municipal Code.

#### Where can I get more information about this project?

The complete file for this project is available for public inspection; please contact the project planner listed above to make necessary arrangements.

### What can I do if I have comments on the project?

Comments or objections to the project can be made by writing or through e-mailed testimony prior to and oral testimony during the meeting. Written comments citing the project name may be emailed to the project planner listed above or may be mailed or delivered to Pittsburg Planning Division, 65 Civic Avenue, Pittsburg, CA 94565.

Pursuant to Section 65009 of the California Government Code, if you challenge this matter in court, you may be limited to those issues you or someone else raised at the public hearing described in this notice, or in written correspondence on the matter delivered to this agency at, or prior to the public hearing. Any written correspondence delivered to the Planning Division before the hearing body's action on the matter will become a part of the administrative record.

Para información en español: (925) 252-4920

JOHN FUNDERBURG, SECRETAR PITTSBURG PLANNING COMMISSION





**CONTRA COSTA COUNTY FIRE PROTECTION DISTRICT** 



4005 PORT CHICAGO HWY, STE 250, CONCORD, CA 94520 • (925) 941-3300 • CCCFPD.ORG

August 7, 2024

Mr. Maurice Brenyah-Addow City of Pittsburg Planning

Subject:TI for Fisherman Catch Store2685 E Leland, Pittsburg

### CCCFPD Project No.: P-2024-002632

Dear Mr. Brenyah-Addow

We have reviewed the design review to establish a TI of an existing 8074 SF building to a seafood processing and grocery store at the subject location. The following is required for Fire District approval in accordance with the 2022 California Fire Code (CFC), the 2022 California Building Code (CBC), the 2022 California Residential Code (CRC), and Local and County Ordinances and adopted standards:

Submit Tenant Improvement Plans.

- The developer shall submit building construction plans and specifications for the subject project to the through the Fire District public portal (<u>https://confire.vision33cloud.com/citizenportal/app/landing</u>). After the new construction / tenant improvement plans are approved, plans and specifications for all deferred submittals shall be submitted, including, but not limited to the following.
  - Carbon Dioxide Systems
  - Commercial kitchen hood extinguishing systems

All plan submittals shall be submitted to the through the <u>Fire District public portal</u> (<u>https://confire.vision33cloud.com/citizenportal/app/landing</u>) for review and approval <u>prior</u> to construction of the building or installation of the systems to ensure compliance with minimum requirements related to fire and life safety. Plan review and inspection fees shall be submitted at the time of plan review submittal. (105.4.1) CFC, (901.2) CFC, (107) CBC

TO SCHEDULE A FIRE DISTRICT INSPECTION OF THE ACCESS AND HYDRANT INSTALLATION PRIOR TO CONSTRUCTION OR THE STORAGE OF COMBUSTIBLE MATERIAL ON THE JOB SITE, CONTACT THE FIRE DISTRICT (MINIMUM 2 WORKING DAYS IN ADVANCE) AT 925-941-3300 EXT 3902 OR SCHEDULE THROUGH THE FIRE DISTRICT PUBLIC PORTAL UNDER THE CORRECT PERMIT NUMBER.

https://confire.vision33cloud.com/citizenportal/app/landing

Our preliminary review comments shall not be construed to encompass the complete project. Additional plans and specifications may be required after further review.

If you have any questions regarding this matter, please contact this office at (925) 941-3300.

Sincerely,

Mild/~

Michael Cameron Fire Inspector

File: 2685 EAST LELAND RD-PLN-P-2024-002632

### **Building Divisions COA Comments**

- On the cover sheet, please indicate the building Design Codes applicable to this project. The City of Pittsburg has adopted and enforces the following building Design Codes: 2022 California Administrative Code (CAC), 2022 California Building (CBC), 2022 California Historical Building Code (CHBC), 2022 California Existing Building Code (CEBC), 2022 California Green Building Standards Code (CGBSC), 2022 California Mechanical Code (CMC), 2022 California Plumbing Code (CPC), 2022 California Electrical Code (CEC), 2022 California Energy Code (CEC Part 6), 2022 California Fire Code and the Pittsburg Municipal Code (RMC). Reference CRC Sec. R106.
- 2. On the cover sheet, please verify the Drawing Index includes all plan sheets. And design criteria. Reference CRC section R106
- 3. The preparation of plans and documents shall be prepared by a registered design professional where required per statutes of the City of Pittsburg where the project is being built. The licensed architect or engineer shall affix a stamp to the plans as evidence of the person's responsibility for the documents. Licensed Mechanical, Plumbing and Electrical Contractors may design the systems that they are to install. On plans not required to have a design professional and are designed by a plans designer shall sign every sheet.
- 4. The Site Plan shall show the size and location of the new construction and existing structures on the site and distances from lot lines and other structures, and include where the residence ties into sewer, power and water from the street.
- 5. All supporting documents are included but are not limited to, truss plans and calculations with a letter of approval for the trusses by the EOR. Energy calculations and all other pertinent information for this project.

Nick Henderson, CBO

City of Pittsburg

### Odor Management Plan - Fisherman's Catch (2685 East Leland Road)

- 1. Enclosed Processing Areas: All processing activities will be conducted in fully enclosed areas to prevent odor escape. These spaces will maintain negative air pressure to further ensure that no untreated air escapes into the external environment. Doors will be equipped with air curtains to minimize air exchange when opened and closed. <u>No cooking or boiling of seafood shall be permitted in the</u> processing areas or on-site.
- 2. Regular Maintenance and Cleaning Protocols: Understanding that cleanliness is critical in controlling odors, Fisherman's Catch will implement strict cleaning protocols. Processing equipment, floors, and surfaces will be cleaned multiple times throughout the day using odor- neutralizing cleaning agents. Additionally, all waste and processing materials will be promptly and properly disposed of (as shown in the attachments) to prevent decay and odor development on-site.
- 3. Waste Management and Storage: Fish/seafood waste, which is a primary source of processing odors, will be handled meticulously. We will use sealed containers and refrigerated storage to inhibit bacterial growth and odor until the waste can be removed from the site. Waste will be transported off-site daily, adhering to the highest standards of sanitary control. We also will utilize vendors who will buy the waste in order to make fertilizer. This will not only help reduce odors, but also reduce waste.
- 4. Employee Training: Our team will receive quarterly comprehensive training focused on operational best practices and rapid response measures for any potential odor issues. By ensuring all employees are knowledgeable about the importance of odor control and trained in effective techniques, we can maintain a consistently odorminimized environment.
- 5. Ongoing Monitoring and Community Engagement: Fisherman's Catch will implement continuous monitoring of odor control measures. This data will be reviewed monthly to ensure compliance with odor management standards. Fisherman's Catch is dedicated to implementing a robust odor control strategy that employs the latest technologies and best practices in industry. We understand the importance of maintaining a pleasant and healthy environment for both our employees and the neighboring community. Our commitment is not only to comply with all local environmental regulations but to strive for leadership in sustainable and responsible business practices.

The City of Pittsburg Community and Economic Development Department staff reserves the right to inspect the business for review and enforcement of the above odor management plan measures as regularly needed to ensure compliance. ZA Hearing October 9, 2024 Attachment 9

Attachments:

- Picture 1 Tallow Bin
- Picture 2 Tallow Bin
- Picture 3 Tallow Bin

### Picture 1



### Picture 2



### Picture 3



### STANDARD CONDITIONS OF DEVELOPMENT

(Planning Commission Resolution No. 8931)

All projects approved by the Planning Commission must meet the following standard conditions unless specifically exempted by the Commission or Council.

A. <u>Project Site</u>.

1. The applicant shall comply with all regulations and code requirements of the Building Division, Engineering Division, Contra Costa Fire Protection District, the Police Department and any other agencies requiring review of the project. If required, these agencies shall be supplied copies of the final building and site plans.

2. Developer shall provide written notification to adjacent property owners for any drainage work required to collect or convey storm water runoff, which may or will affect their properties.

3. During construction water trucks or sprinkler systems are to be used in sufficient quantities to prevent dust from leaving the site during any earthmoving and/or construction activities. Nonpotable water shall be used from a source approved by the City Engineer. (Title 15 of PMC)

4. Continuous 6" high Portland Concrete Cement curbing shall be provided between all driveways and landscaped areas as indicated in the City of Pittsburg Standard Details. In addition to above, curbing between length of parking space and landscaped area shall include a 12" wide "Courtesy Curb."

5. CC&R's (Covenants, Conditions and Restrictions) for the project shall contain appropriate provisions for joint maintenance of any infrastructure, roadways, utilities, landscaping and irrigation as determined necessary by the City Engineer.

6. Developer shall submit a study addressing on and off-site storm water and sewer system capabilities. If the study indicates that the present system is inadequate, the developer must provide plans and install any additional storm water and sanitary and sanitary sewer facilities including off-site improvements to correct storm water runoff and sanitary sewer demands anticipated for upstream buildout in accordance with the Pittsburg General Plan.

7. Environmental and engineering studies, as directed by the Planning and Building Director, must be complete and on file prior to commencement to plan checking. Developer shall install off-street improvements determined necessary by the City Engineer to provide safe traffic conditions.

8. Developer shall underground existing and required on and off-site utilities as specified in Chapter 17 of the Municipal Code or as deemed necessary by the City Engineer.

9. All site development shall comply with title 12 (Streets, Sidewalks and Utilities), Title 13 (Water and Sewers) and Chapter 15.88 (Grading, Erosion and Sediment Control) of the Pittsburg Municipal Code as determined by the City Engineer. Issuance of a site development permit will be required whereby specific engineering requirements will be made as conditions of approval of that permit.

10. The CC&R's shall restrict the storage of recreational vehicles on this site or parcels unless they are the principle source of transportation for the owner and prohibit parking on the public street for long than 72 hours.

11. All retaining wall adjacent to public right-of-ways shall be provided with decorative treatment, subject to approval by the Planning Division.

12. The design of any masonry soundwall shall be approved by the Planning and Building Department. It shall match or harmonize with existing soundwalls of neighboring projects along that street.

B. <u>Architecture</u>.

1. All mechanical, irrigation, ground and/or roof mounted equipment shall be architecturally screened from view from all public right-of-ways prior to issuance of certificate of occupancy.

2. All trash enclosures shall be constructed of masonry material with selfenclosing doors and have a second access. The enclosure shall have materials and colors consistent with the primary building.

3. All vents, gutters, downspouts, flashing electrical conduits, etc., shall be painted or finished to match the color of the adjacent surface unless otherwise directed by the Planning Commission.

4. Soffits and other architectural elements visible from view but not detailed on the plans shall be finished in a material in harmony with the exterior of the building.

5. Finish quality of exterior design elements including, but not limited to, building façade landscaping shall be subject to approval of the Planning Division prior to issuance of Certificate of Occupancy.

### C. Landscaping.

1. Specific landscaping for screening shall have an appearance of mature growth subject to a field check and approval by the

Planning Division prior to Certificate of Occupancy.

2. The area under the drip line of all existing trees, which are to be saved, shall be fenced during construction. Grading shall be restricted under them to prevent soil compaction around the trees and to protect them from damage.

3. An existing tree inventory shall be created and included on the site plan for all new projects prior to approval of grading plan.

4. All slope banks in excess of five (5) feet in vertical height and 2:1 or greater slope shall be landscaped and irrigated for erosion control and to soften their appearance as follows: one 15-gallon or larger size tree per each 150 sq. ft. of slope area, one 1gallon or larger size shrub per each 100 sq. ft. of slope area, and appropriate ground cover 12-24 inches on-center. In addition, slope banks in excess of eight (8) feet in vertical eight and 2:1 or greater slope also include one 5-gallon or larger size tree per each 250 sq. ft. of slope area. Trees and shrubs shall be planted in staggered clusters to soften and vary slope plane. Slope planting required by this condition shall include a permanent irrigation system to be installed by the developer prior to occupancy.

6. All planting shall be maintained in good growing condition. Such maintenance shall include, where appropriate, pruning, mowing, weeding, cleaning of debris and trash, fertilizing and regular watering. Whenever necessary, planting shall be replaced with other plant materials to insure continued compliance with applicable landscaping requirements. Required irrigation systems shall be fully maintained in sound operating condition with heads periodically cleaned and replaced when missing to insure continued regular watering of landscape areas, and health and vitality of landscape materials.

### D. General Requirements

1. Final inspection for occupancy permits will not be granted until all construction and landscaping is complete in accordance with approved plans.

2. The applicant shall defend, indemnify and hold harmless the City of Pittsburg, its agents, officers, and employees from any claim, action, or proceeding against the City or its agents, officers, or employees to attack, set aside, void or annul this approval, or any aspect of the City's consideration of applicant's project. The applicant recognizes and agrees that applicant's voluntary commitment to meet the obligations described in this condition is an integral factor in the City's approval of this project. The intent of this condition is to require the applicant to bear the cost of any and all litigation instituted to overturn or in any way modify the City's approval of this project. Such costs include without limitation, any award of attorney's fees and costs to a prevailing plaintiff or petitioner. In the event the city becomes aware of any such claim, action, or proceeding, the City shall promptly notify the applicant and shall cooperate fully in the defense. If the City fails to promptly notify the applicant, or if the City fails to cooperate fully in the defense, the applicant shall not thereafter be responsible to defend, indemnify, or hold harmless the City. Nothing contained in this condition prohibits the City from participating in the defense of any claim, action, or proceeding, it both the following occur: (a) the City bears its own attorneys' fees and costs; and (b) the City defends the action in good faith. The applicant shall not be required to pay or perform any settlement unless the applicant approves the settlement.

3. It is required by State Law (Business and Professional Code Section No. 5537 & 5538 and Section 302(b) of the Uniform Building Code) that all commercial buildings, new or existing must have a licensed professional designer (Architect, Civil or Structural

Engineer) to design all changes of use or occupancy as well as new construction.

4. The Applicant shall submit a complete area water pressure availability study for all phases of the Project prior to issuance of any development permits. If the study indicates that the present system is inadequate, the Applicant must provide plans, which will demonstrate any remedial action necessary to abate the deficiency and shall take all necessary actions at the applicant's expense.

5. This use permit may be recalled to the Planning Commission for review at any time due to complaints regarding lack of compliance with conditions of approval, traffic congestion, noise generation, or other adverse operating characteristics. At such time, the Commission may revoke the use permit or add/modify conditions approval.

6. It is the responsibility of the applicant or developer to check with each agency for requirements that may pertain to their project.

7. All signs shall be submitted to the Planning Division for design review per Title 19 of the Pittsburg Municipal Code.

8. All landscape areas shall be maintained in a healthy, thriving and weed free condition.

9. The site shall be maintained in a neat and clean manner free of trash and debris.

10. All outdoor mechanical equipment, satellite dishes, fire main and all rooftop equipment shall be fully visually screened upon installation subject to the approval of the Planning Division. Screening devices shall be shown on construction and/or landscape plans.

11. All exterior light fixtures shall be shown on plans subject to staff review and approval. All lights attached to buildings shall provide a soft "wash" of light against the wall. All building and parking or yard lights shall conform to City Parking Standards 18.78.050 (F) and Performance Standards 18.82.030 (B) and shall compliment the site and building architecture.

12. Prior to occupancy, the developer shall supply the City with an ACAD computer disk file showing plans that reflect the project as it was build (As-Builts) at the discretion of the Planning and Building Director.

E. <u>Standard Conditions of Approval</u> <u>Requiring Minimum Construction Site</u> <u>Management Practices</u>

# 1. (Projects involving land disturbances of less than five (5) acres) – During

construction activities, the project sponsor shall reduce or prevent to the maximum extent practicable the direct or indirect discharge of any pollutant into the storm drain system utilizing best management practices contained in the California Storm Water Best Management Practices Handbook for Construction Activities. Construction activities include, but are not limited to: watering operations; roadwork and paving operations; concrete and painting; structure construction and painting; construction material storage and handling; construction waste/debris storage and disposal; and, construction equipment/vehicle cleaning, maintenance and fueling operations. The project sponsor is also responsible for training all contractors and subcontractors on the best management practices which are identified in the California Storm Water Best Management Practices Handbook for Construction Activities which will be available at the pre-construct meeting of the project.

#### or

#### 2. (Projects involving land disturbances of five (5) acres or more) – Prior to commencement of any site work that will

result in a land disturbance of five acres or more, the project sponsor shall submit to the City a copy of the Notice of Intent (NOI) sent the State Water Resources Control Board and the Stormwater Pollution Prevention Plan (SWPPP) prepared for the project, as required by the State's General Construction Activity Permit.

3. All storm drains, which serve the site, shall be protected from spills and soil runoff (from unpaved parking areas). The applicant may use "Any Source Control" BMP (Best Management Practice) as listed in the California Storm Water Best Management Practice Handbook for storm water run-ff for commercial and industrial sites. Storm drains will be inspected periodically. Questions may be referred to City NPDES Coordinator, at 252-4920.